




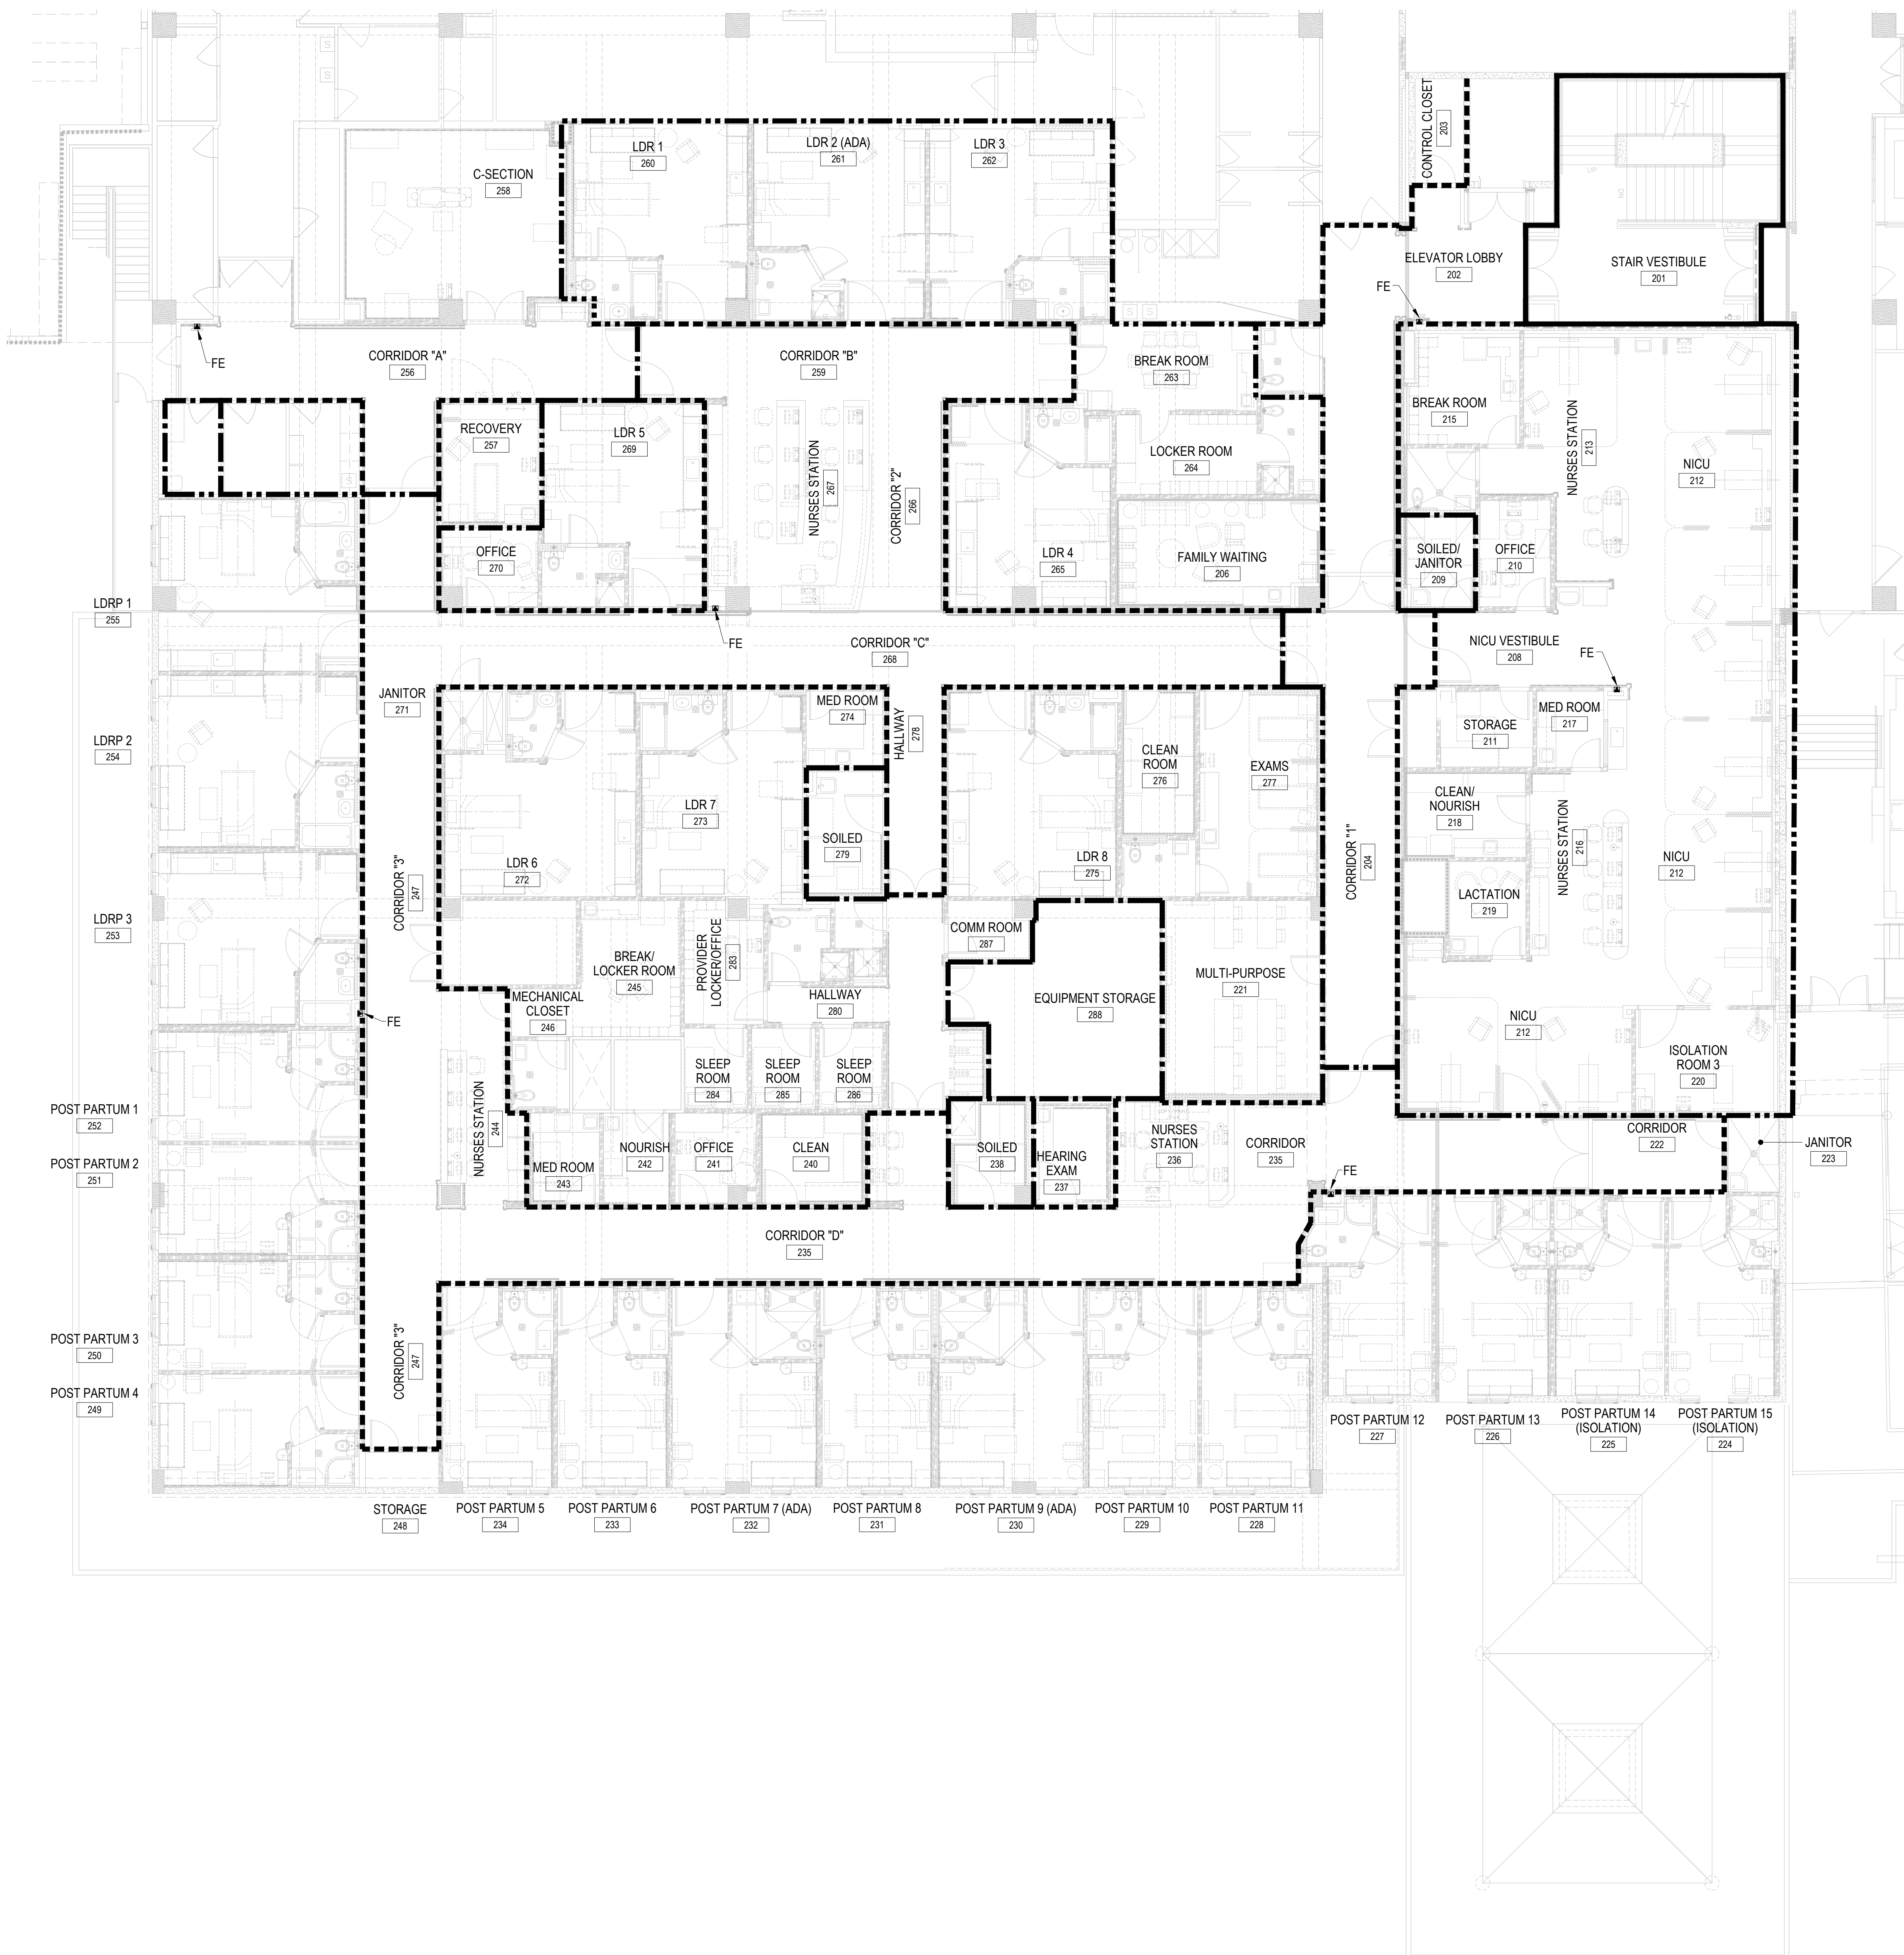



EGRESS TABLE		
TOTAL FLOOR AREA	9,500 SQUARE FEET	
TOTAL NUMBER OF OCCUPANTS	80 PERSONS (CALCULATED)	
EXIT WIDTH REQUIRED	LEVEL - 12 INCHES	STAIRS - 16 INCHES
EXIT WIDTH PROVIDED	LEVEL - 84 INCHES	STAIRS - 76 INCHES
MAXIMUM TRAVEL DISTANCE	115 FEET	
MAXIMUM DEAD END CORRIDOR	14 FEET	
MAXIMUM COMMON PATH OF TRAVEL	57 FEET	

LIFE SAFETY PLAN LEGEND


-  SMOKE TIGHT PARTITION
-  ONE HOUR RATED FIRE PARTITION
-  ONE HOUR RATED FIRE/SMOKE PARTITION
-  TWO HOUR RATED FIRE PARTITION
-  10lb ABC EXTINGUISHER IN SEMI-RECESSED CABINET



1
LS201
PARTIAL SECOND FLOOR LIFE SAFETY PLAN
1/8" = 1'-0"

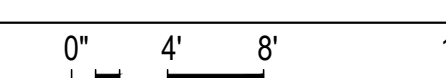

I CERTIFY THAT THIS DRAWING WAS PREPARED BY ME OR UNDER MY RESPONSIBLE CONTROL.

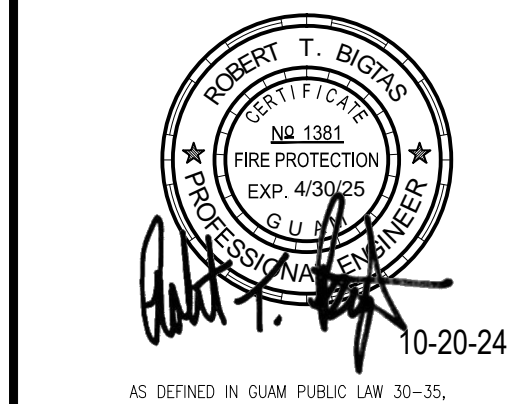

AS DEFINED IN GUAM PUBLIC LAW 30-35, SECTION 23116

PERMIT SET

MCH RENOVATION PROJECT, GMHA 007-2014
GMHA FAMILY BIRTH CENTER
 850 GOVERNOR CAMACHO ROAD, OKA, TAMUNING, GUAM 96913
 GUAM MEMORIAL HOSPITAL AUTHORITY
 PARTIAL SECOND FLOOR LIFE SAFETY PLAN


PROJECT TITLE: _____
 OWNER: _____
 SHEET TITLE: _____

MARK	DATE	DESCRIPTION


DATE : 2024.10.25
 PROJECT NO : 144052.02
 DRAWN BY : RJL
 CHECKED BY : RJL
 COPYRIGHT : 2024 RIM Architects
 DWG NO: **LS201**

GENERAL NOTES:

1. THE FIRE SPRINKLER SYSTEM SHOWN IS CONCEPTUAL. THE EQUIPMENT IS SHOWN IN SUGGESTED LOCATIONS. FINAL QUANTITY AND LAYOUT SHALL BE IN ACCORDANCE WITH APPLICABLE CODES, MANUFACTURER'S RECOMMENDATIONS, AND EQUIPMENT LISTING. SHOP SUBMITTAL SHALL SHOW SPRINKLER DETAILS IN ACCORDANCE WITH NFPA 13 AND THE MANUFACTURER'S EQUIPMENT LISTING INSTALLATION REQUIREMENTS.
2. ALL COUPLINGS TO BE ZERO FLEX/RIGID UNLESS OTHERWISE NOTED AND/OR REQUIRED BY CODE.
3. SPRINKLER HEADS ARE TO BE CENTERED IN THE ALL SUSPENDED CEILING TILES.
4. PROVIDE SPLIT CHROME WALL PLATES AT ALL EXPOSED PENETRATIONS.
5. ALL ROOMS ARE CLASSIFIED AS ORDINARY HAZARD (0.10 GPM/SQ FT OVER THE REMOTE AREA - 100 GPM HOSE ALLOWANCE) PER NFPA 13 UNLESS OTHERWISE NOTED WITH SYMBOLS BELOW. SEE REMOTE AREA NOTES FOR REMOTE AREA MODIFICATIONS AS APPLICABLE.
6. ALL NEW STANDPIPE HOSE VALVES SHALL BE SUITABLE AND UL LISTED FOR INSTALLATION ON WET STANDPIPE SYSTEMS.

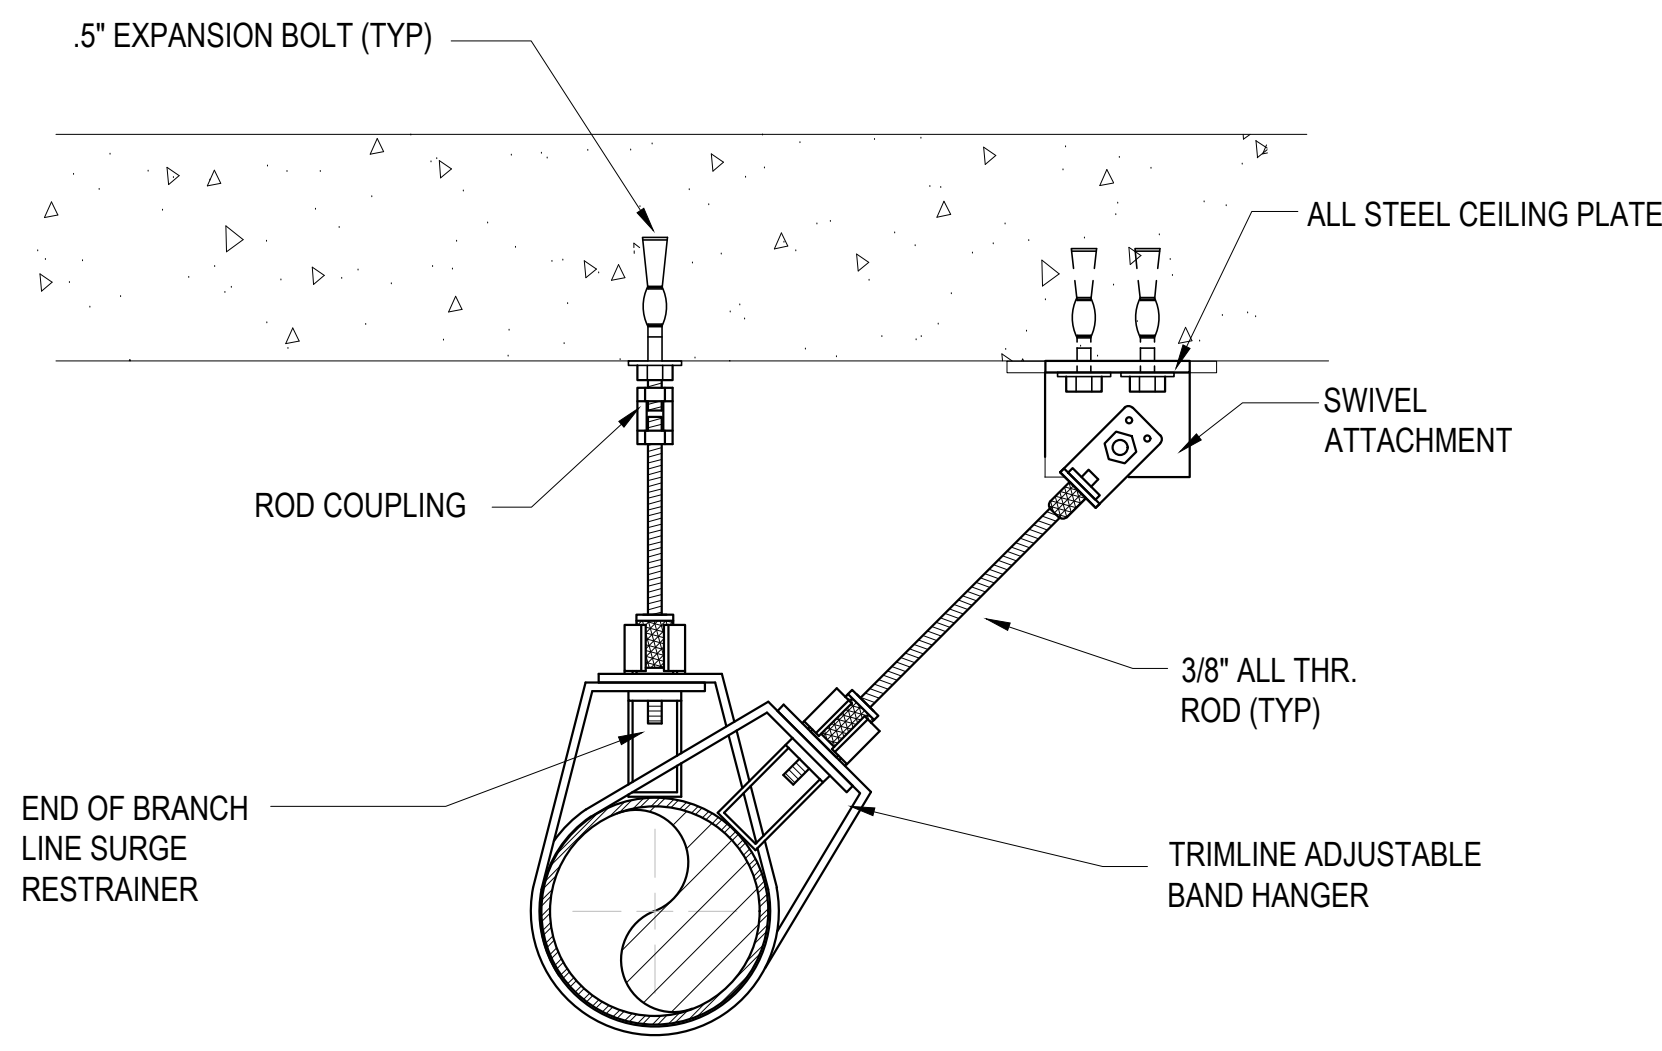


2 PIPE END SUPPORT
FP101

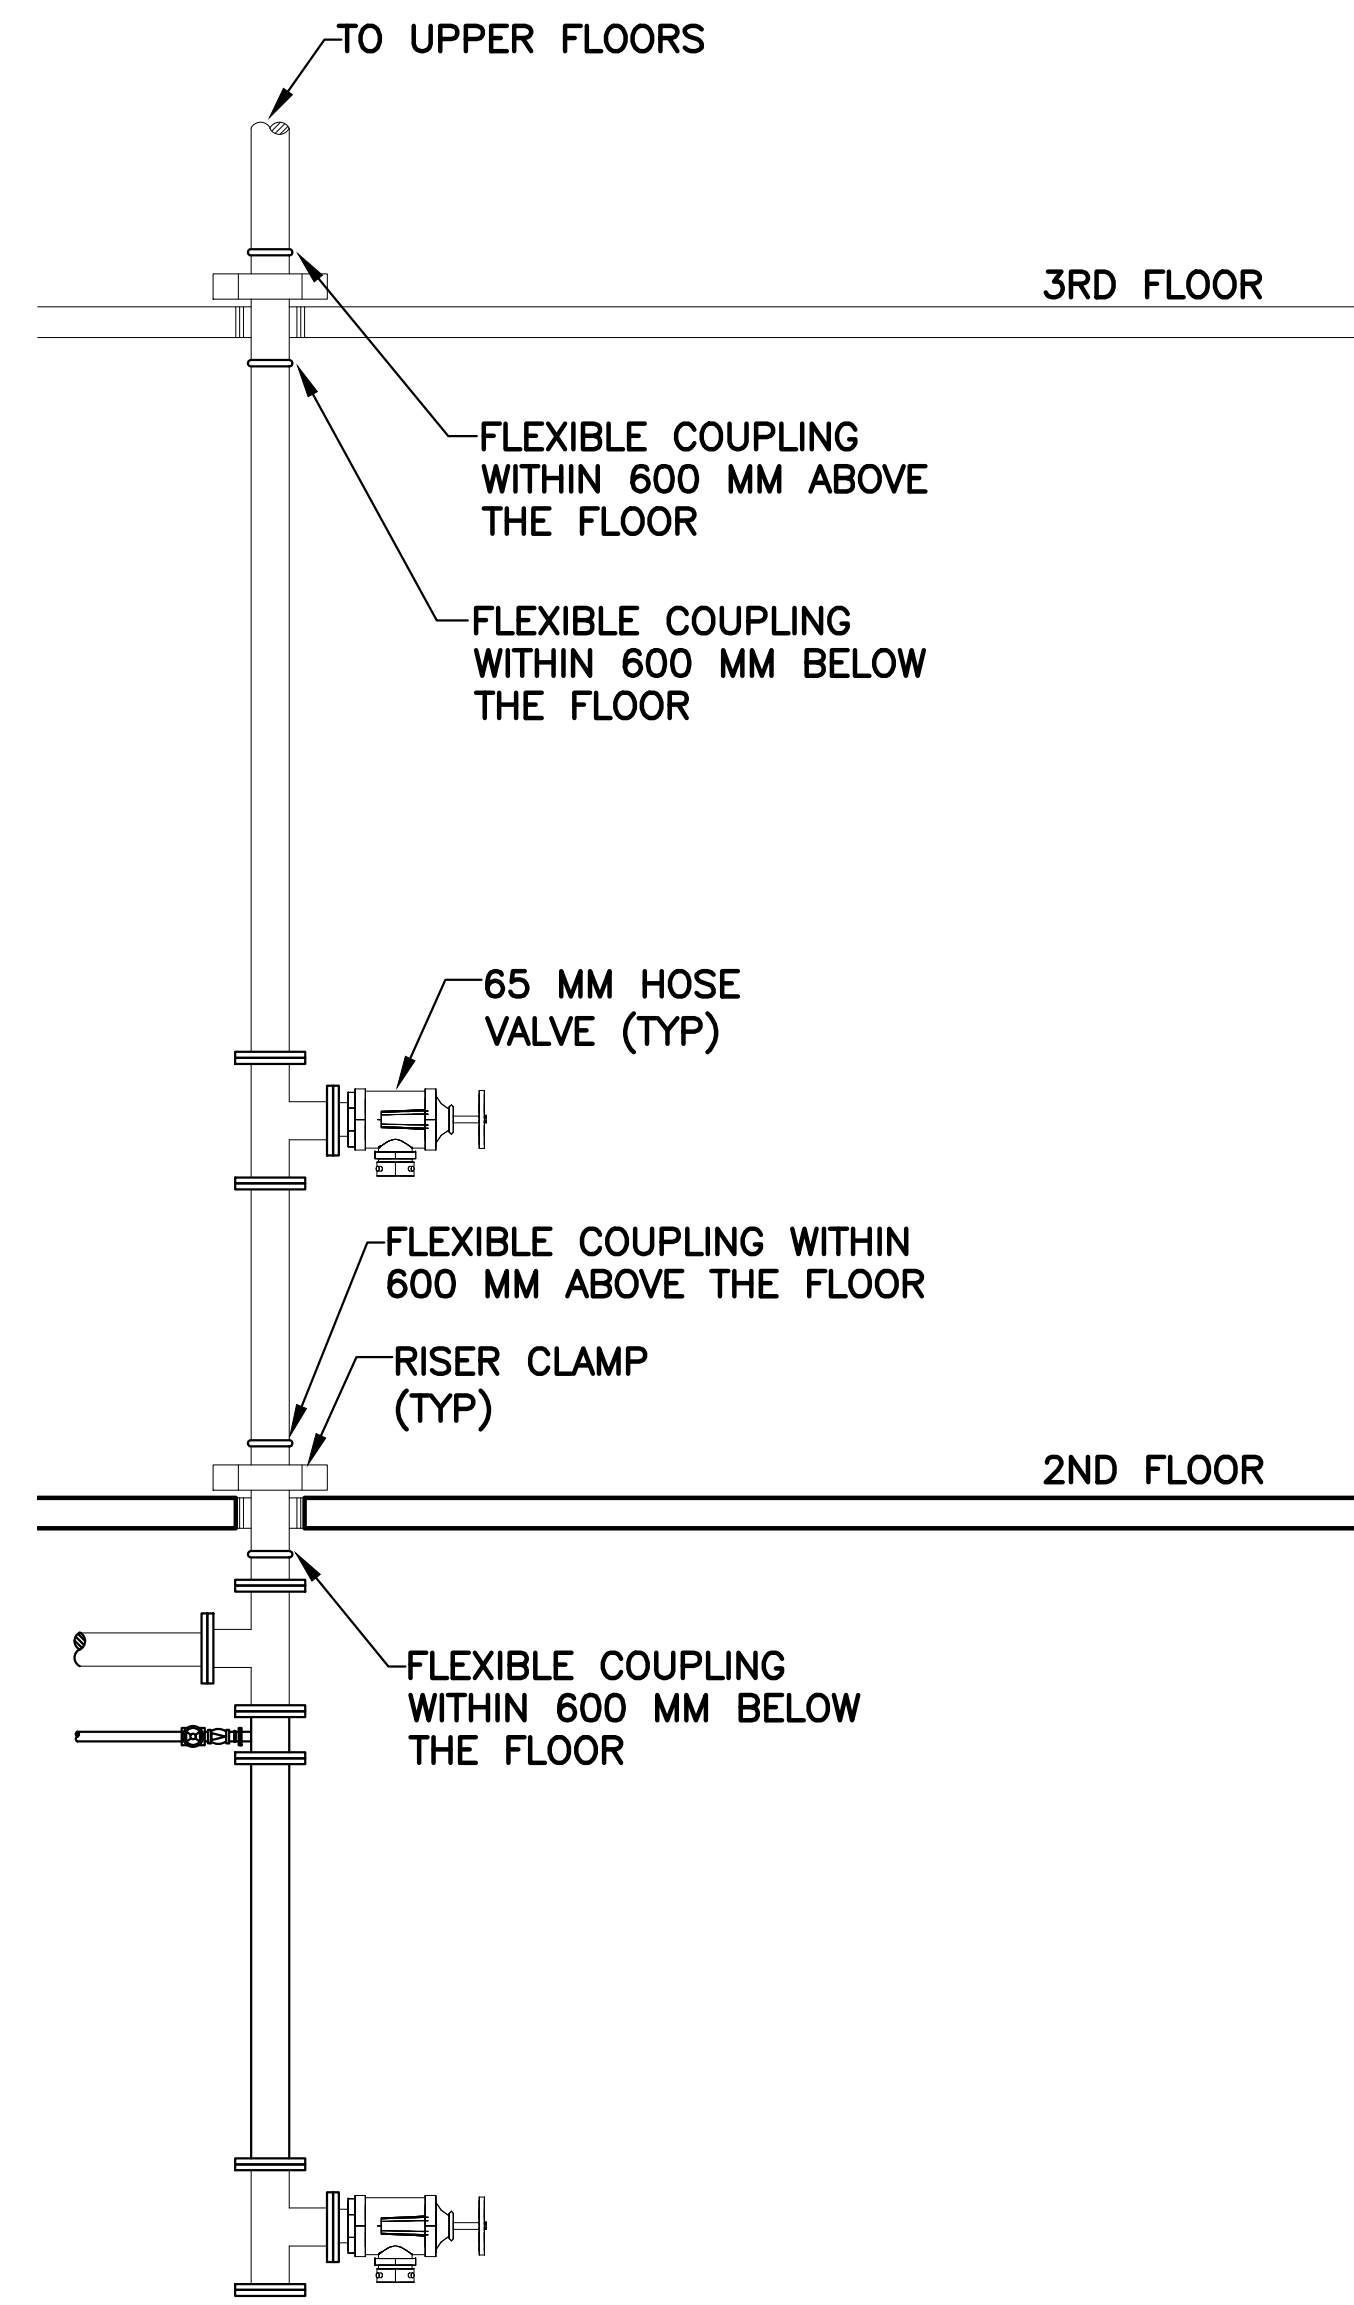

FLEXIBLE COUPLING NOTE:
PROVIDE FLEXIBLE COUPLINGS WHERE REQUIRED BY NFPA 13, SECTION 9.3.2 AND AS INDICATED BELOW:


1. WITHIN 600MM (24 INCHES) OF TOP AND BOTTOM OF FIRE SPRINKLER RISERS.
2. RISERS 900MM TO 2.1M (3FT TO 7FT), ONE FLEXIBLE COUPLING REQUIRED.
3. WITHIN 300MM (12 INCHES) ABOVE AND 600MM (24 INCHES) BELOW THE FLOOR IN MULTISTORY BUILDINGS.
4. WITHIN 600MM (24 INCHES) OF A BUILDING EXPANSION JOINT.
5. WITHIN 600MM (24 INCHES) OF THE TOP OF A DROP EXCEEDING 4.6M (15 FEET) WHERE THE DROP FEEDS MORE THAN 1 FIRE SPRINKLER.
6. ON THE HORIZONTAL PORTION OF WITHIN 600MM (24 INCHES) OF THE TIE-IN WHERE THE TIE-IN IS HORIZONTAL. THIS LOCATION IS ON EVERY FLOOR.

4 WET STANDPIPE SUPPORT DETAIL
FP101

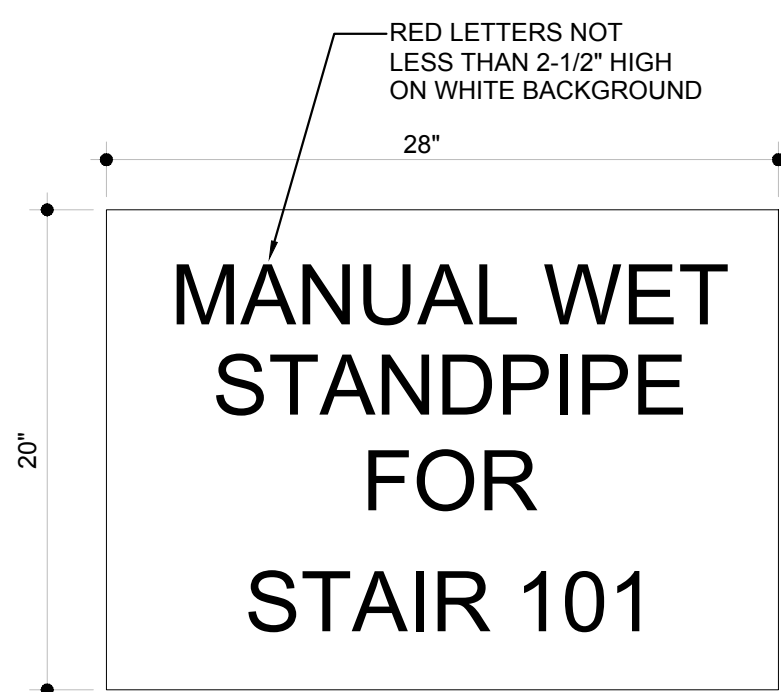


NOTE:
SIGN TO BE PERMANENTLY MARKED WEATHERPROOF METAL OR RIGID PLASTIC SIGN, SECURED WITH CORROSION-RESISTANT WIRE, CHAIN OR OTHER ACCEPTABLE MEANS.

5 SIGN DETAIL
FP101 1-1/2\"/>

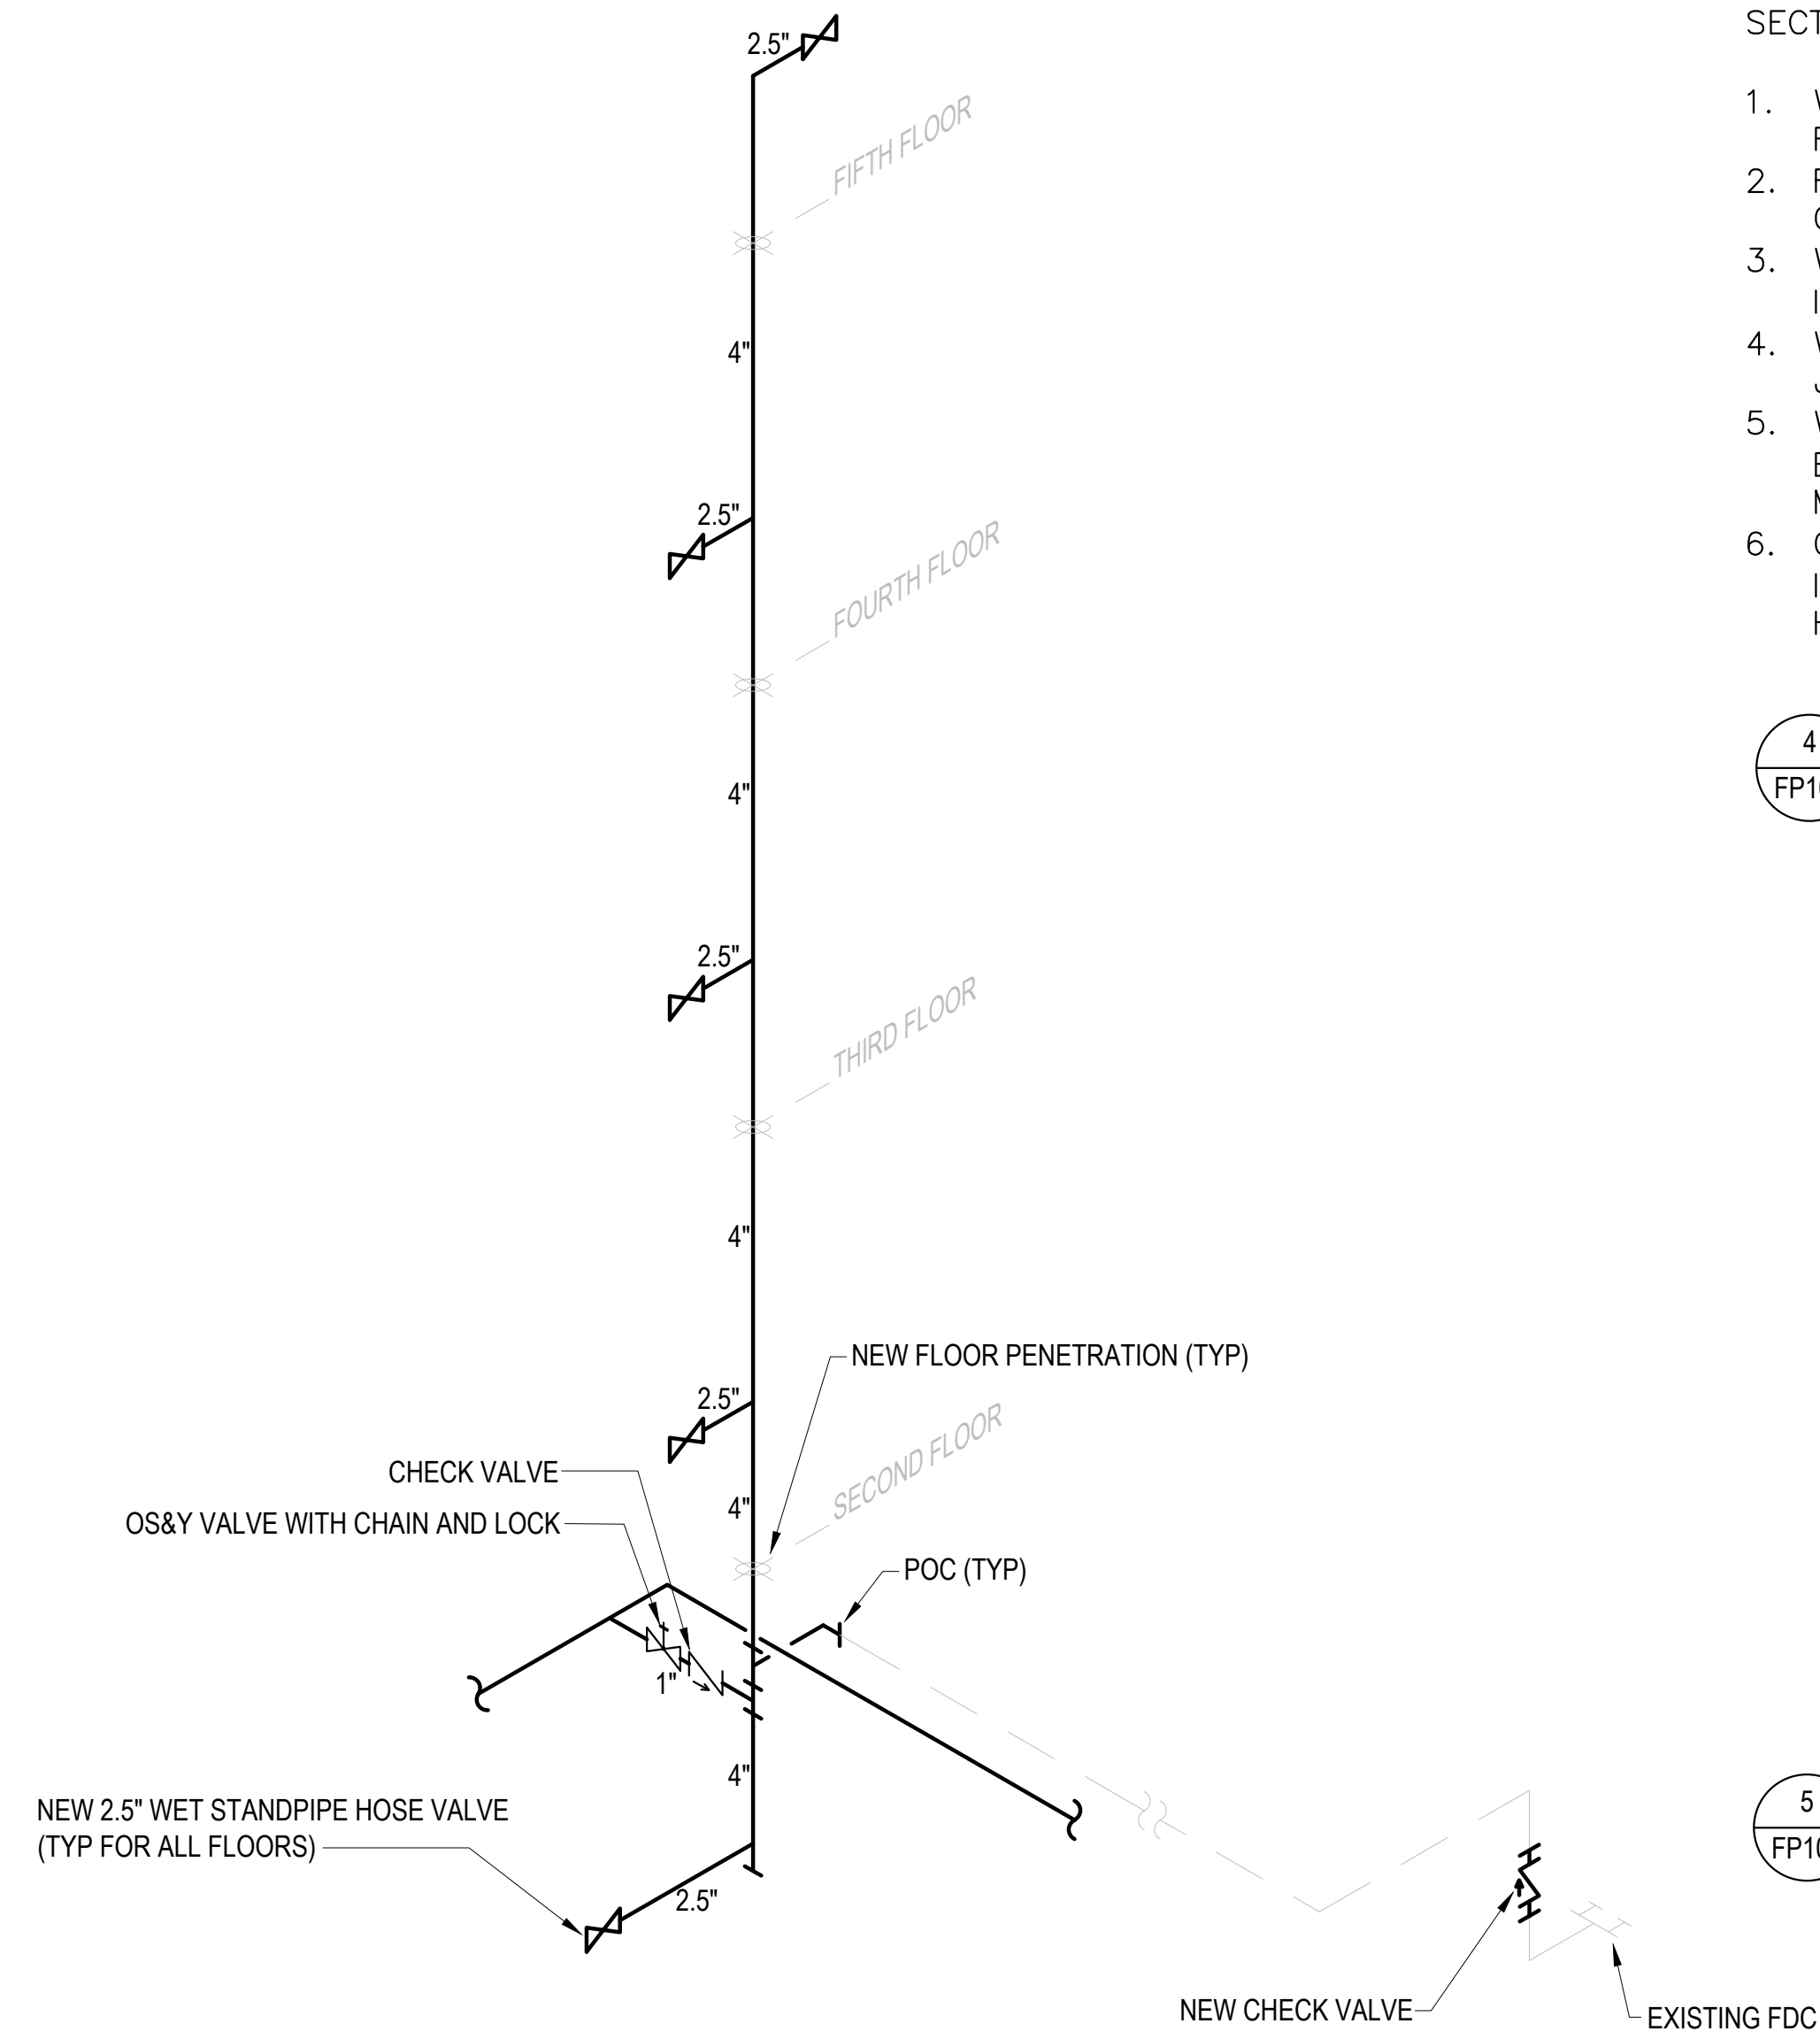

3 STAIR VESTIBULE 101
MANUAL WET STANDPIPE RISER DIAGRAM
FP101

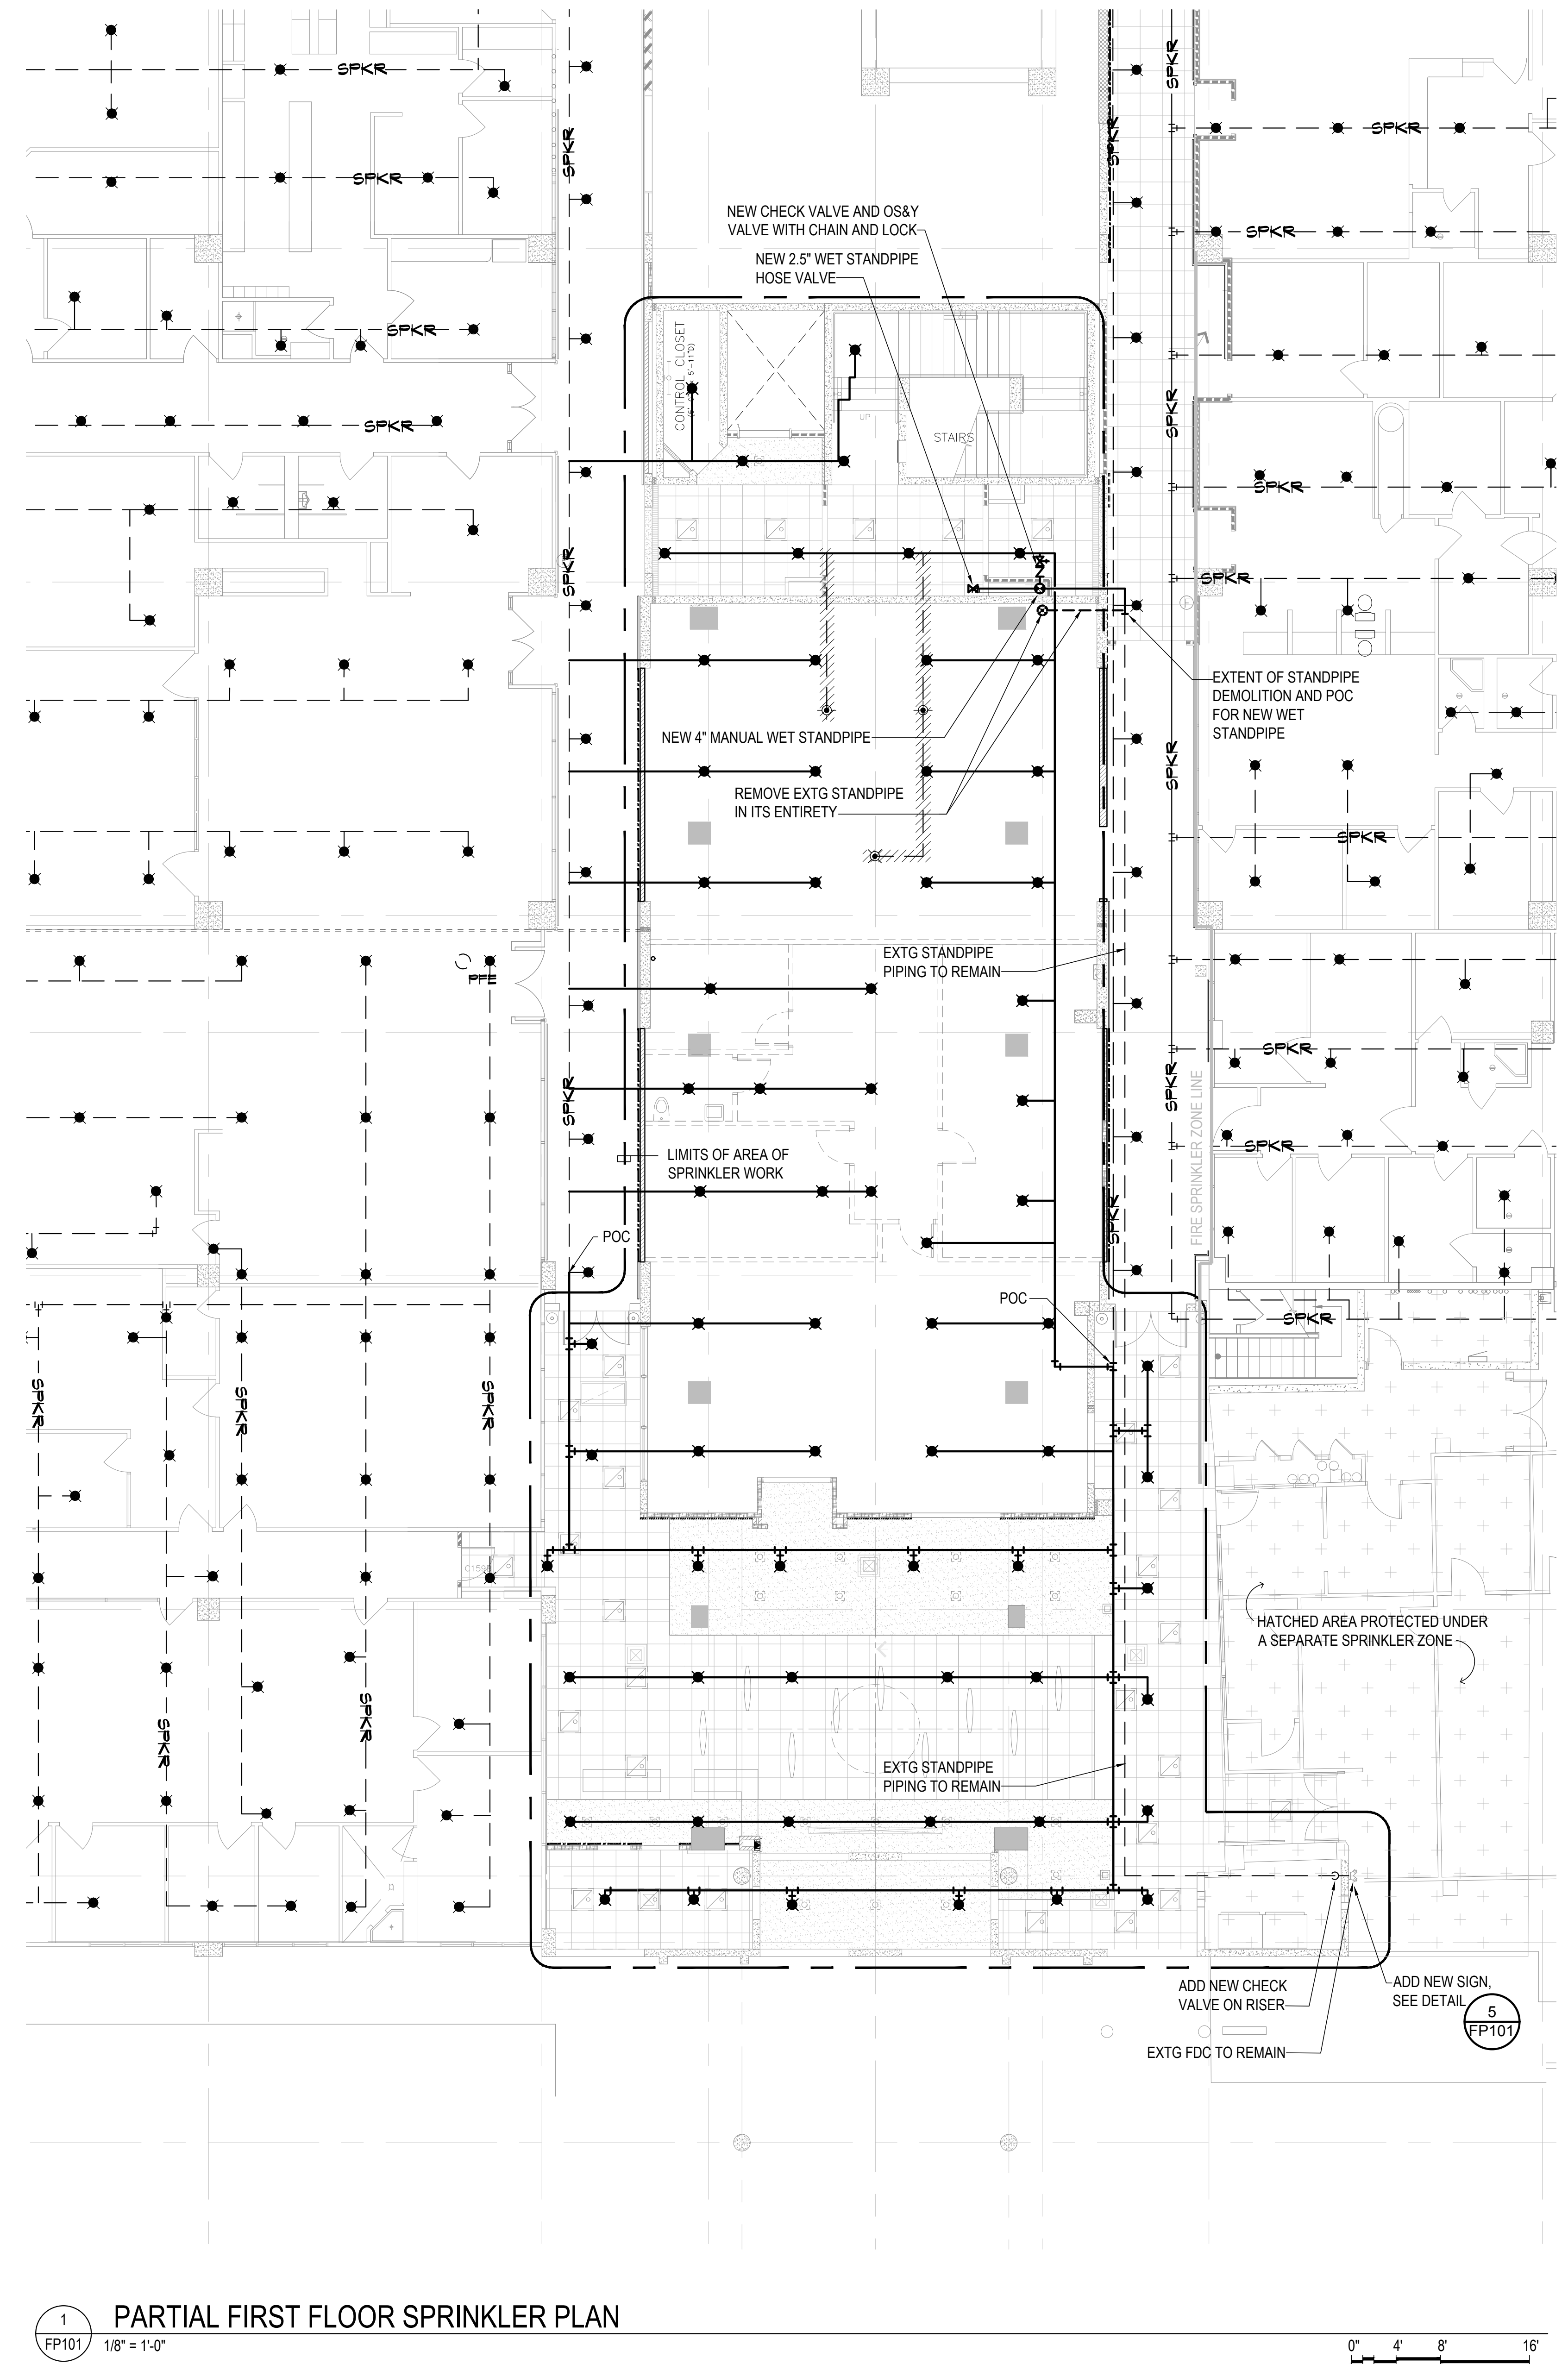

1 PARTIAL FIRST FLOOR SPRINKLER PLAN
FP101 1/8\"/>

I CERTIFY THAT THIS DRAWING WAS PREPARED BY ME OR UNDER MY RESPONSIBLE CONTROL.



AS DEFINED IN GUAM PUBLIC LAW 30-35, SECTION 2316

PERMIT SET

MCH RENOVATION PROJECT, GMHA 007-2014
GMHA FAMILY BIRTH CENTER
850 GOVERNOR CAMACHO ROAD, OKA, TAMUNING, GUAM 96913
GUAM MEMORIAL HOSPITAL AUTHORITY
PARTIAL FIRST FLOOR SPRINKLER PLAN

PROJECT TITLE: OWNER: SHEET TITLE:


MARK	DATE	DESCRIPTION
DATE	: 2024.10.25	
PROJECT NO	: 144052.02	
DRAWN BY	: JBP	
CHECKED BY	: RTB	
COPYRIGHT	: 2024 RIM Architects	

DWG NO:


FP101

GENERAL NOTES:


1. THE FIRE SPRINKLER SYSTEM SHOWN IS CONCEPTUAL. THE EQUIPMENT IS SHOWN IN SUGGESTED LOCATIONS. FINAL QUANTITY AND LAYOUT SHALL BE IN ACCORDANCE WITH APPLICABLE CODES, MANUFACTURER'S RECOMMENDATIONS, AND EQUIPMENT LISTING. SHOP SUBMITTAL SHALL SHOW SPRINKLER DETAILS IN ACCORDANCE WITH NFPA 13 AND THE MANUFACTURER'S EQUIPMENT LISTING INSTALLATION REQUIREMENTS.
2. ALL COUPLINGS TO BE ZERO FLEX/RIGID UNLESS OTHERWISE NOTED AND/OR REQUIRED BY CODE.
3. SPRINKLER HEADS ARE TO BE CENTERED IN THE ALL SUSPENDED CEILING TILES.
4. PROVIDE SPLIT CHROME WALL PLATES AT ALL EXPOSED PENETRATIONS.
5. ALL ROOMS ARE CLASSIFIED AS ORDINARY HAZARD (0.10 GPM/SQ FT OVER THE REMOTE AREA - 100 GPM HOSE ALLOWANCE) PER NFPA 13 UNLESS OTHERWISE NOTED WITH SYMBOLS BELOW. SEE REMOTE AREA NOTES FOR REMOTE AREA MODIFICATIONS AS APPLICABLE.
 (OH1) ORDINARY HAZARD GROUP 1 - 0.15 GPM/SQ FT OVER REMOTE AREA - 250 GPM HOSE
 (OH2) ORDINARY HAZARD GROUP 2 - 0.20 GPM/SQ FT OVER REMOTE AREA - 250 GPM HOSE
6. ALL NEW STANDPIPE HOSE VALVES SHALL BE SUITABLE AND UL LISTED FOR INSTALLATION ON WET STANDPIPE SYSTEMS.

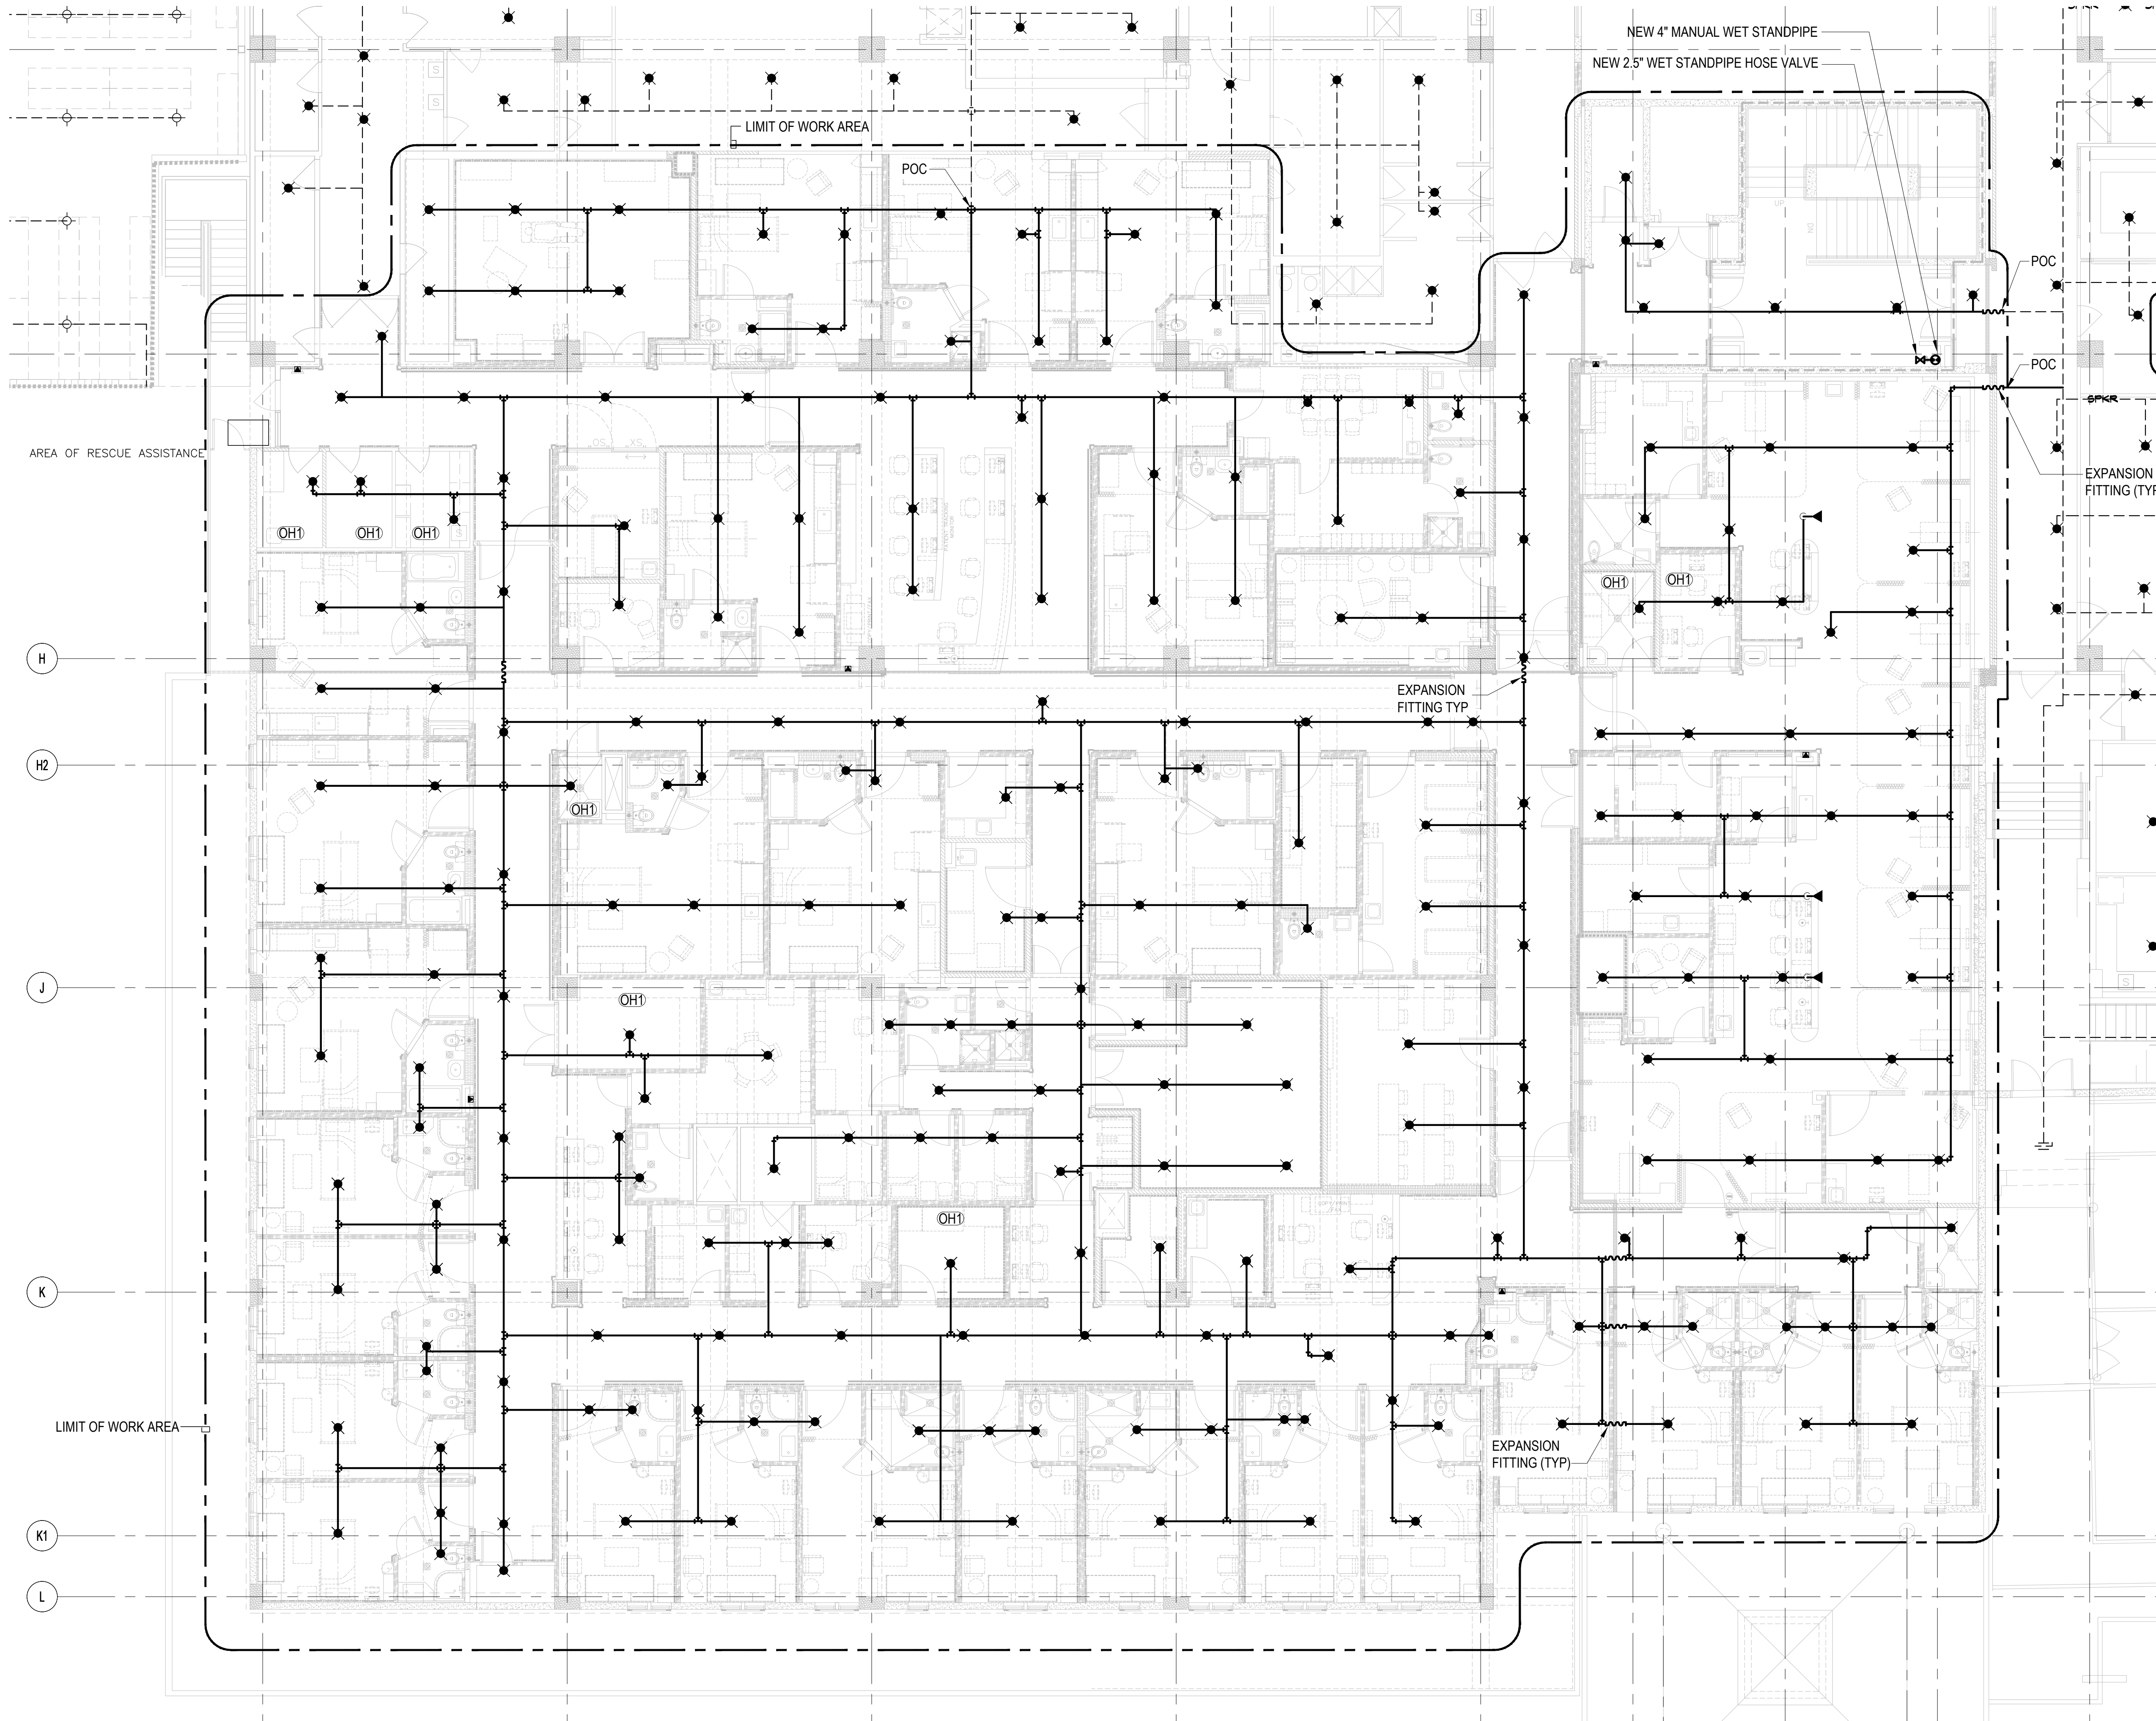


1 PARTIAL SECOND FLOOR SPRINKLER PLAN
 FP201 1/8" = 1'-0"

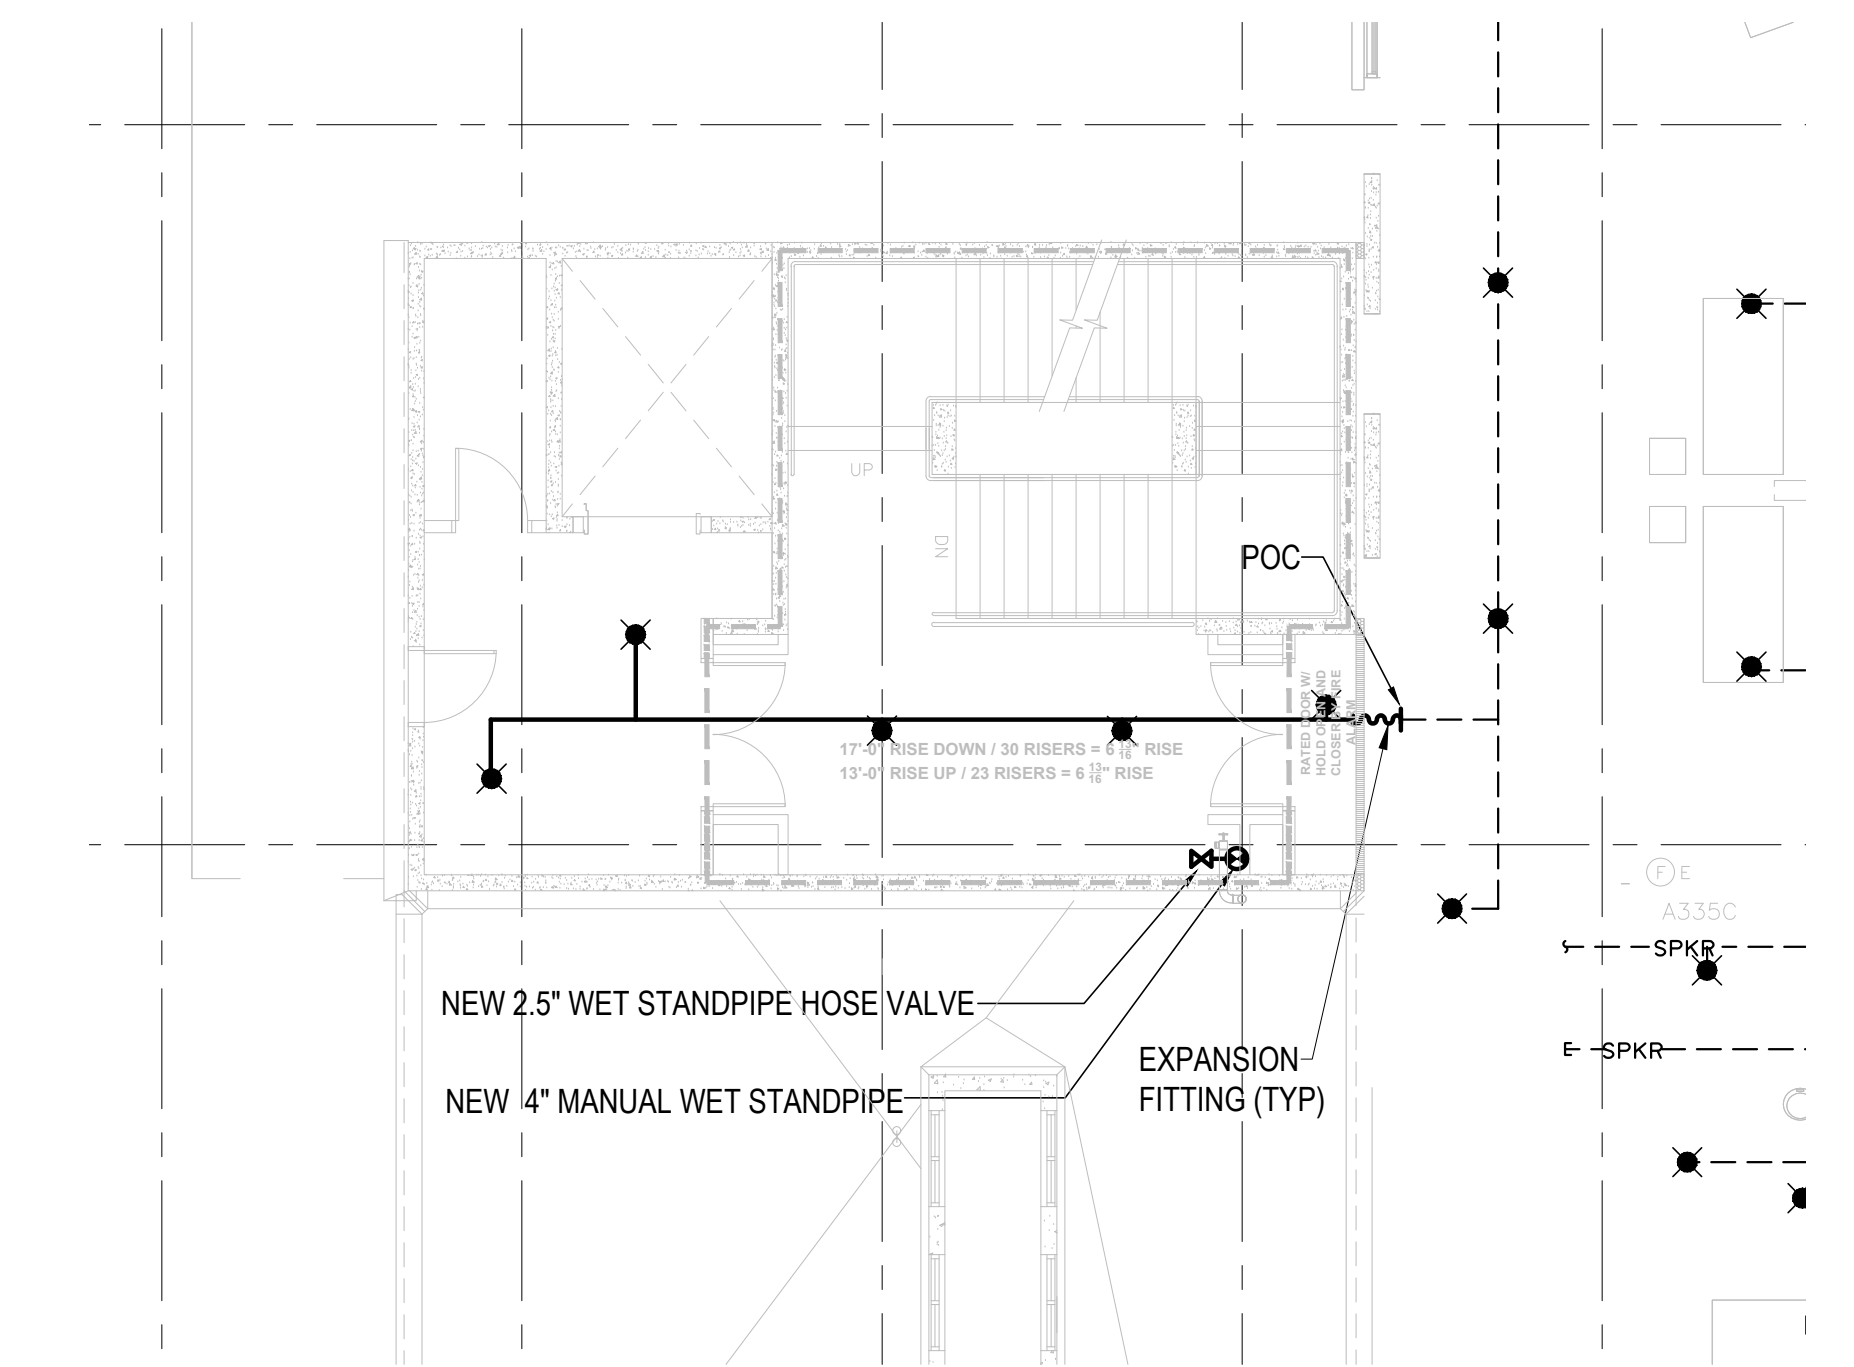


2 PARTIAL THIRD FLOOR SPRINKLER PLAN
 FP201 1/8" = 1'-0"

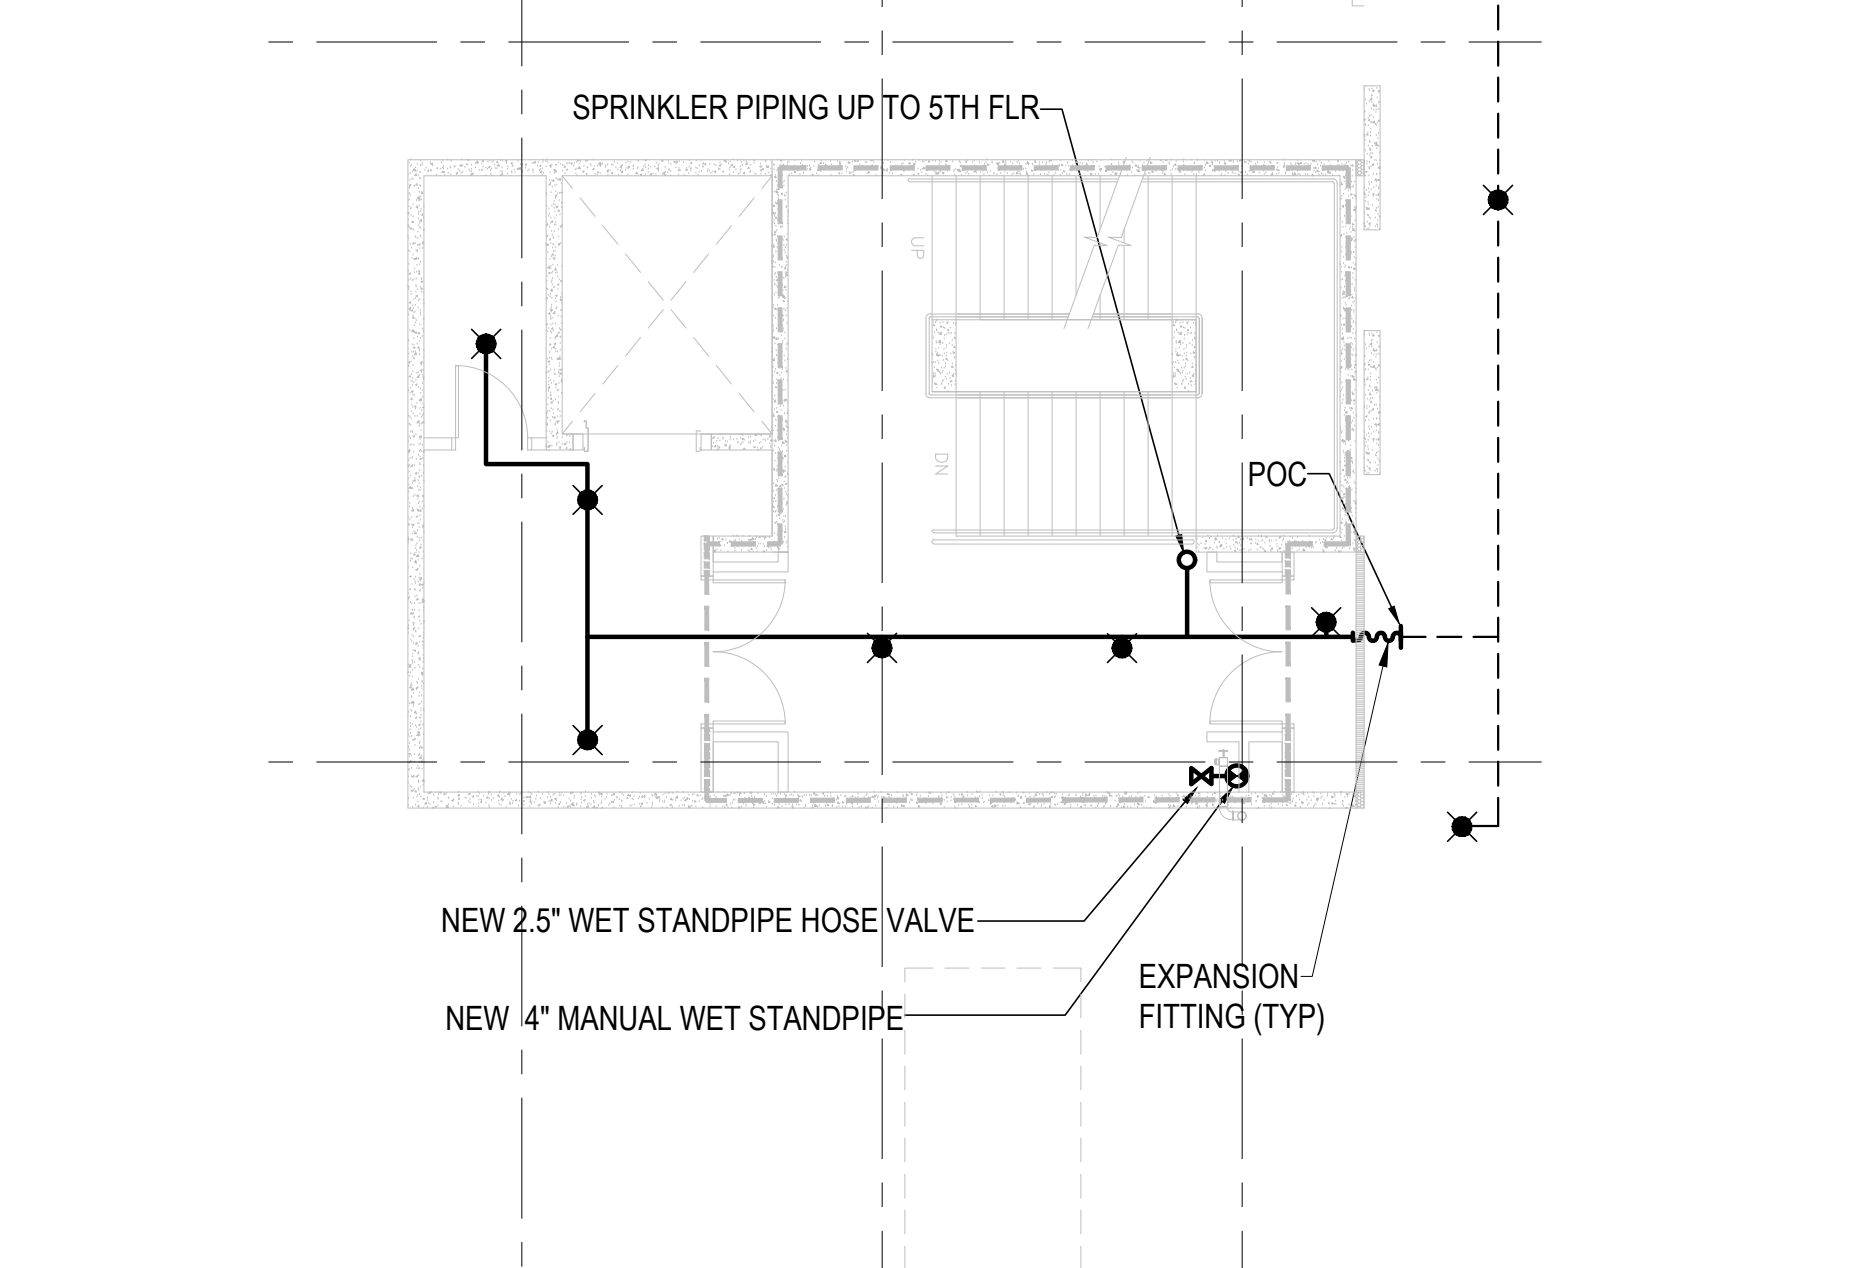

3 PARTIAL FOURTH FLOOR SPRINKLER PLAN
 FP201 1/8" = 1'-0"

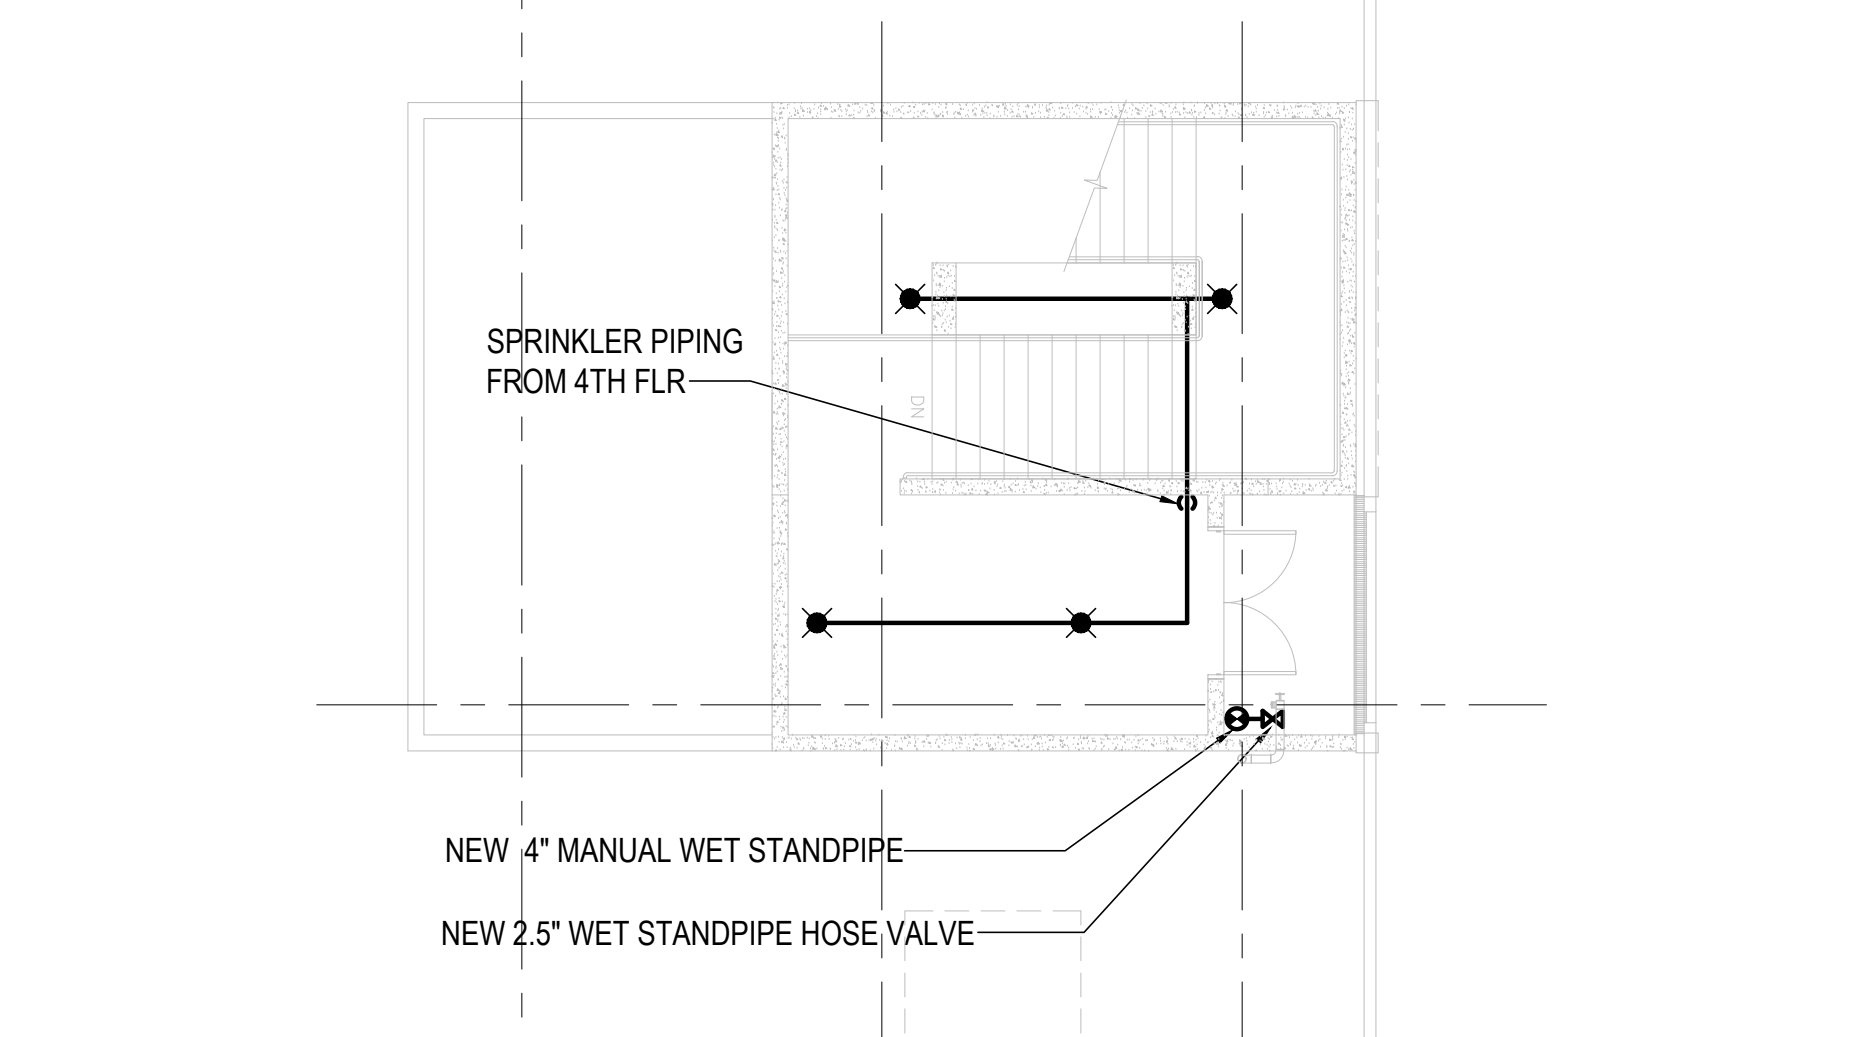

4 PARTIAL FIFTH FLOOR SPRINKLER PLAN
 FP201 1/8" = 1'-0"

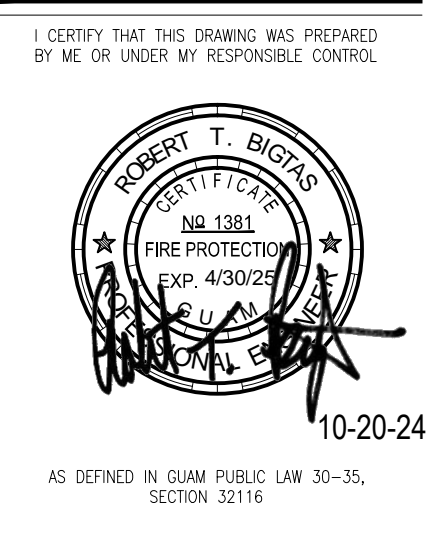


PERMIT SET

MCH RENOVATION PROJECT, GMHA 007-2014
GMHA FAMILY BIRTH CENTER
 850 GOVERNOR CAMACHO ROAD, OKA, TAMPUNING, GUAM 96913
 GUAM MEMORIAL HOSPITAL AUTHORITY
 PARTIAL 2ND, 3RD, 4TH & 5TH FLOOR SPRINKLER PLANS


PROJECT TITLE: _____
 OWNER: _____
 SHEET TITLE: _____

MARK	DATE	DESCRIPTION


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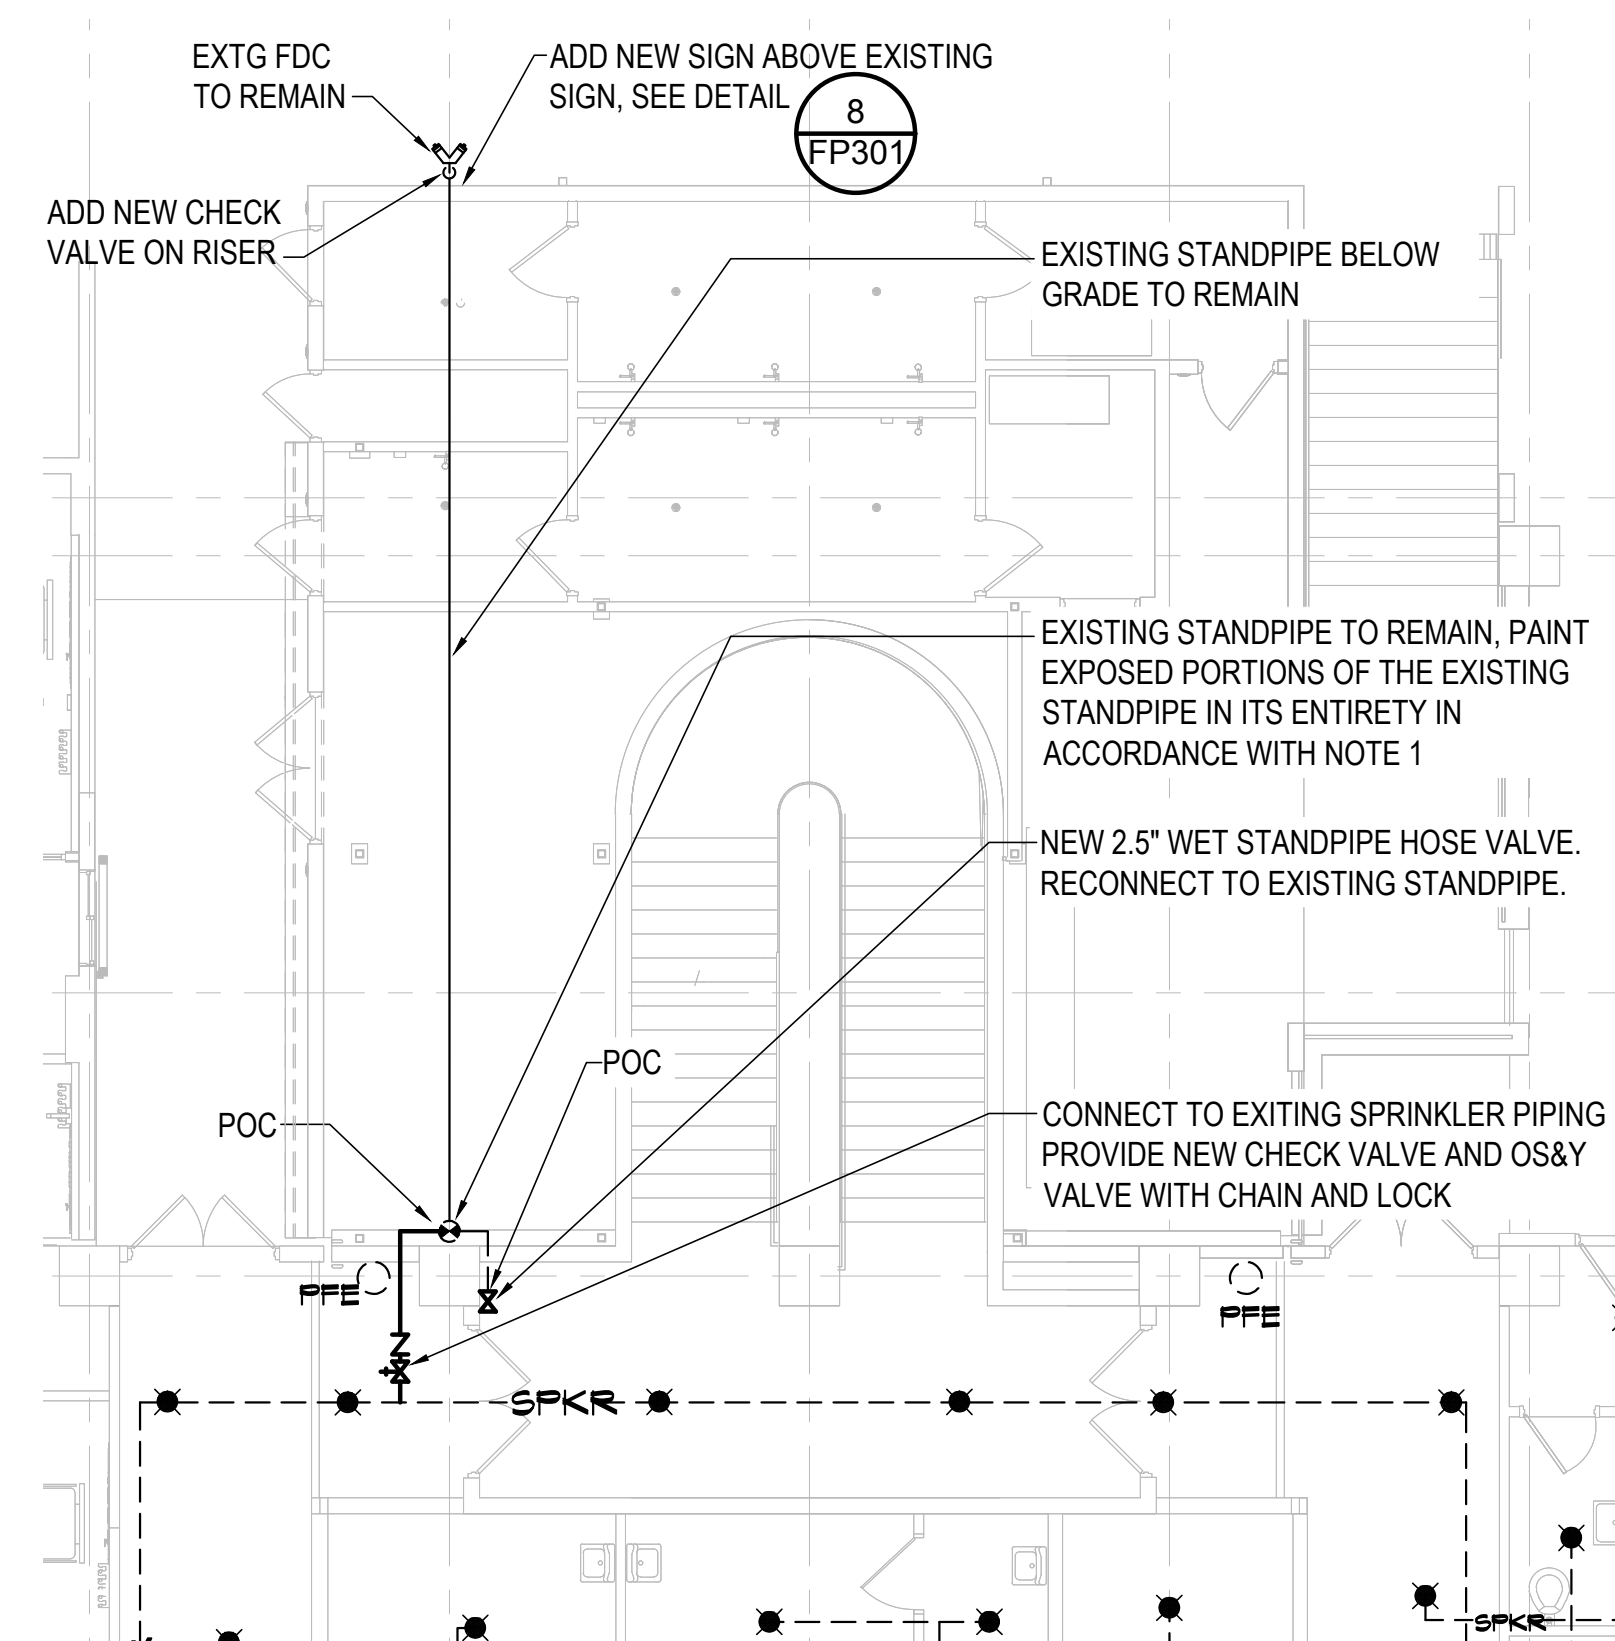
1
FP301 1/16" = 1'-0"
0" 4' 8' 16' 32'

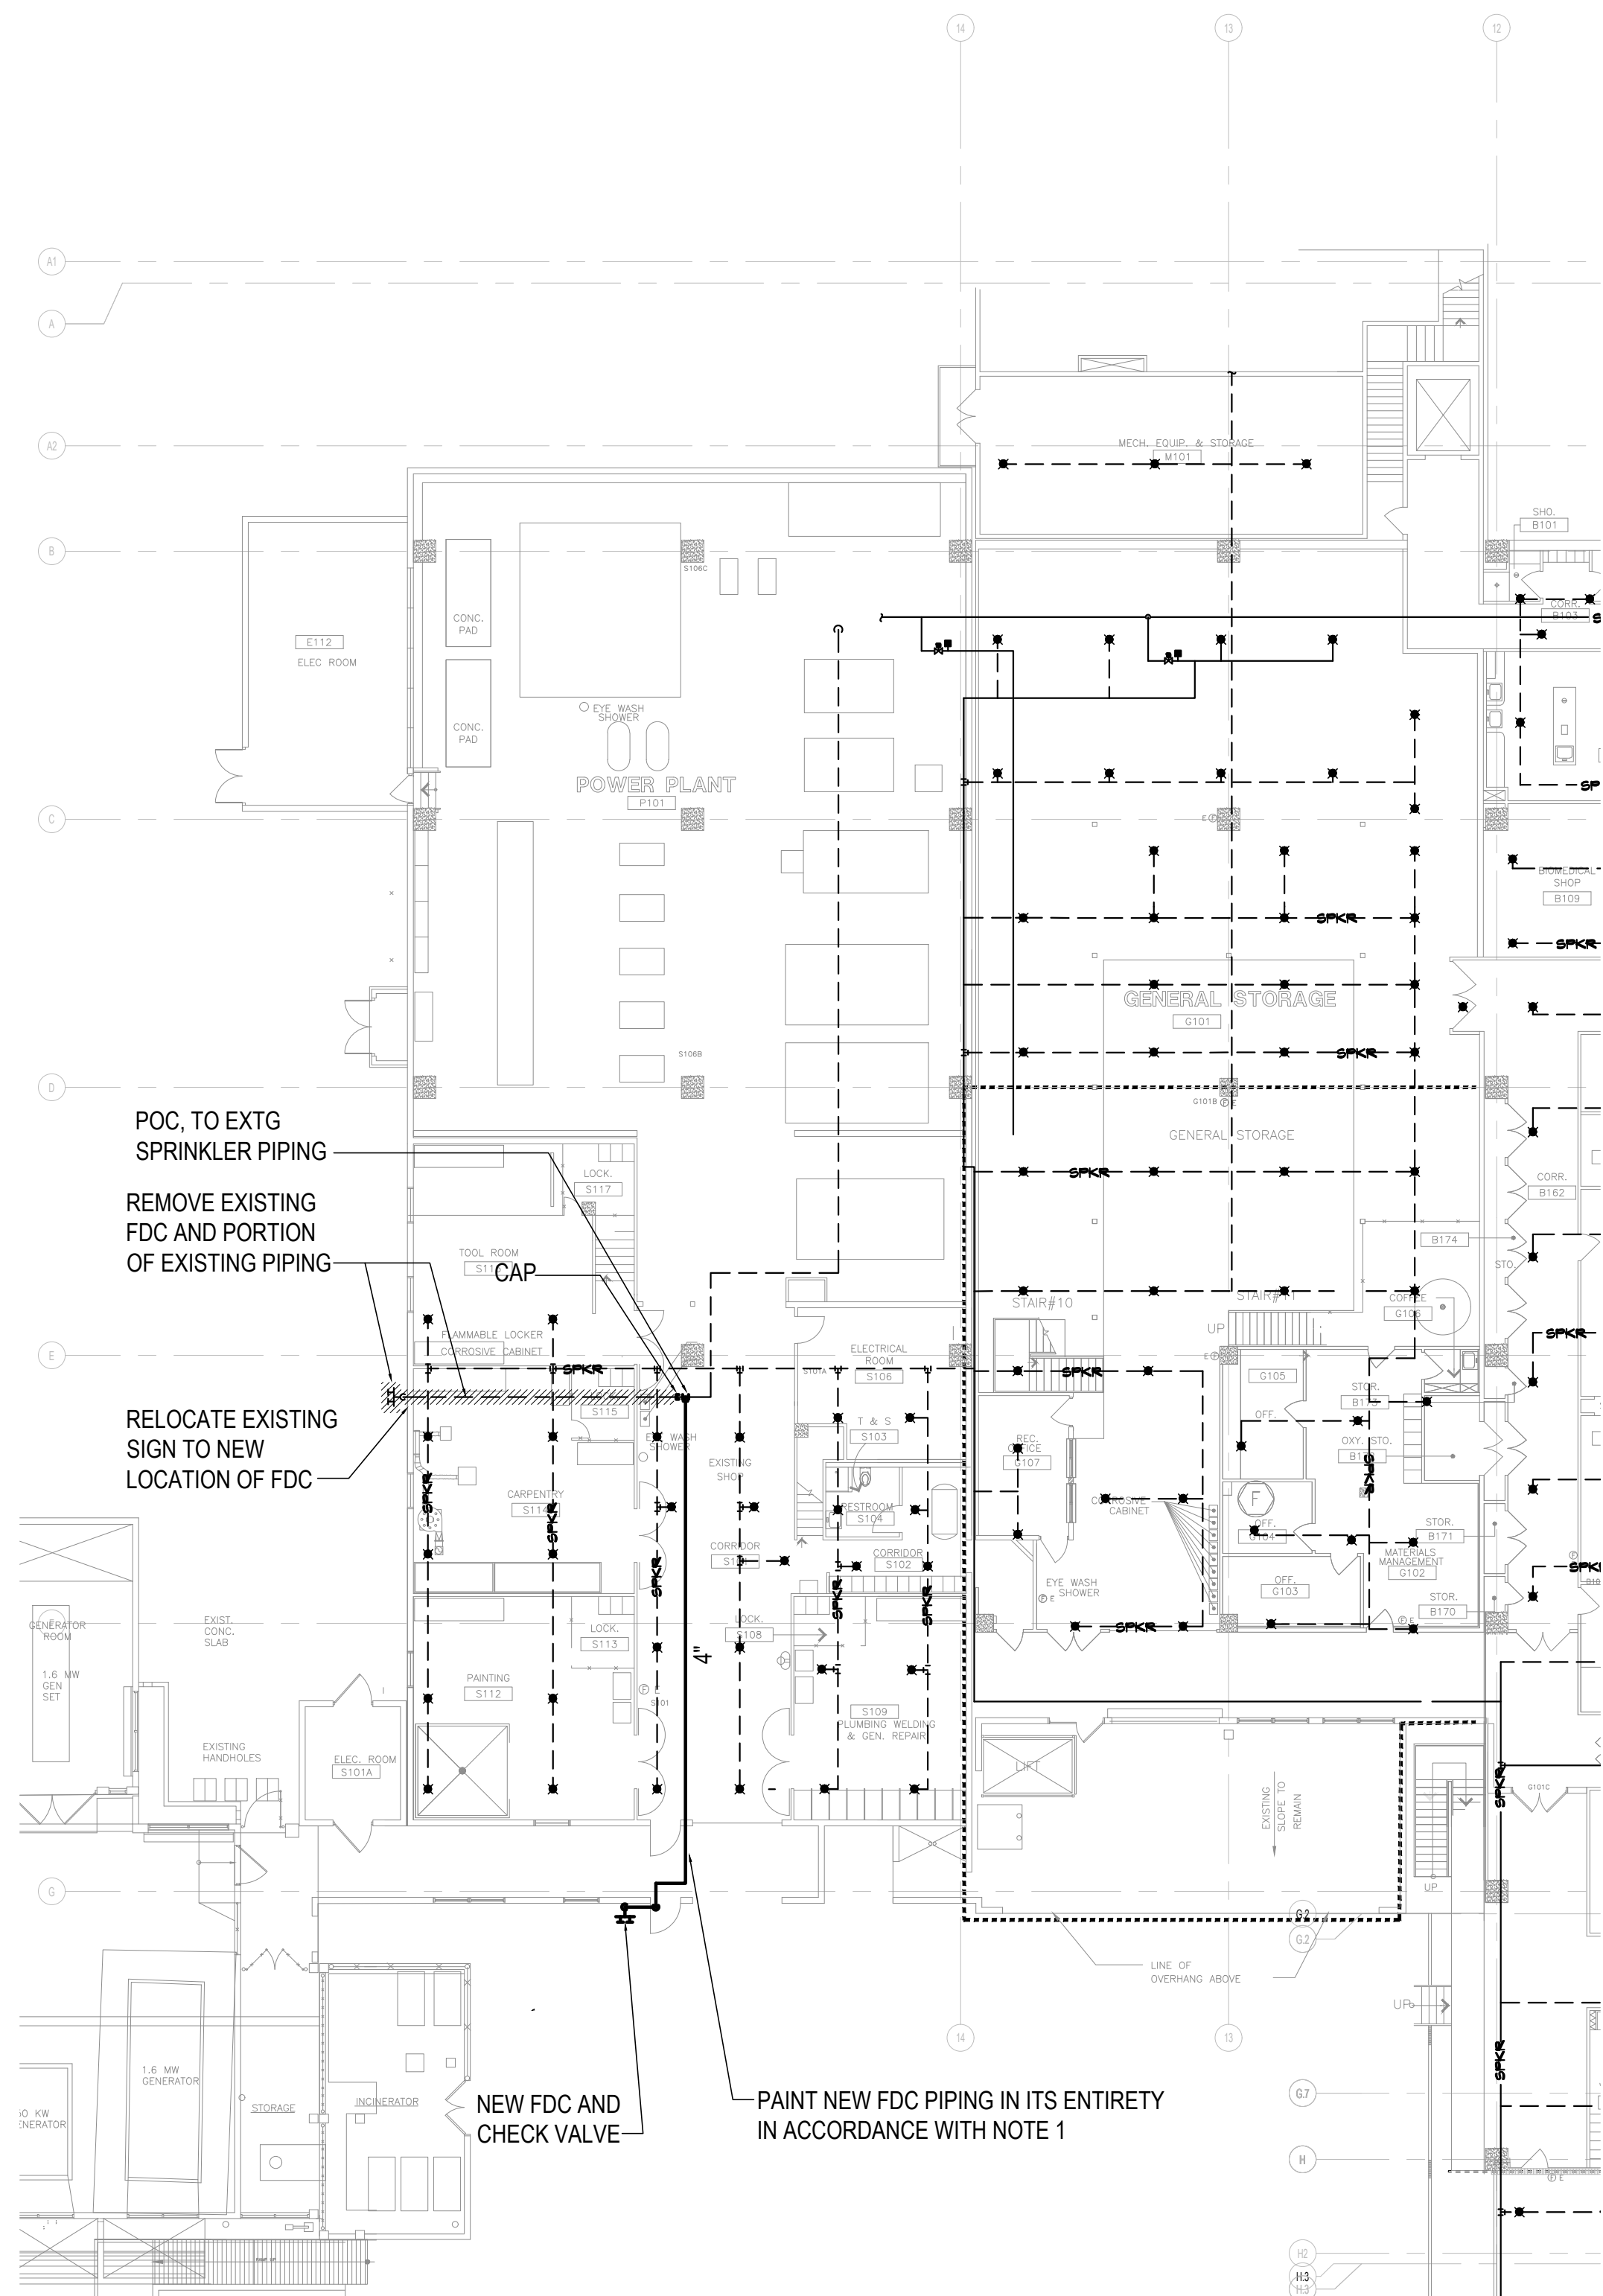


KEY PLAN - POWER PLANT
NOT TO SCALE

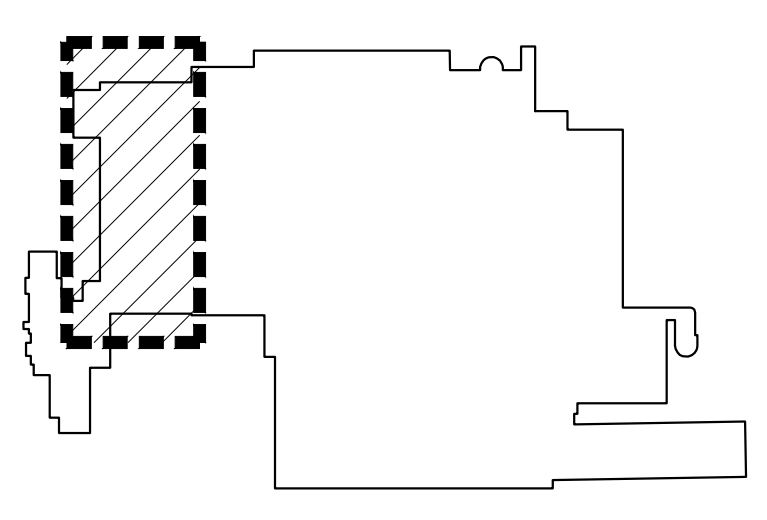


2
FP301 1/8" = 1'-0"
0" 4' 8' 16'

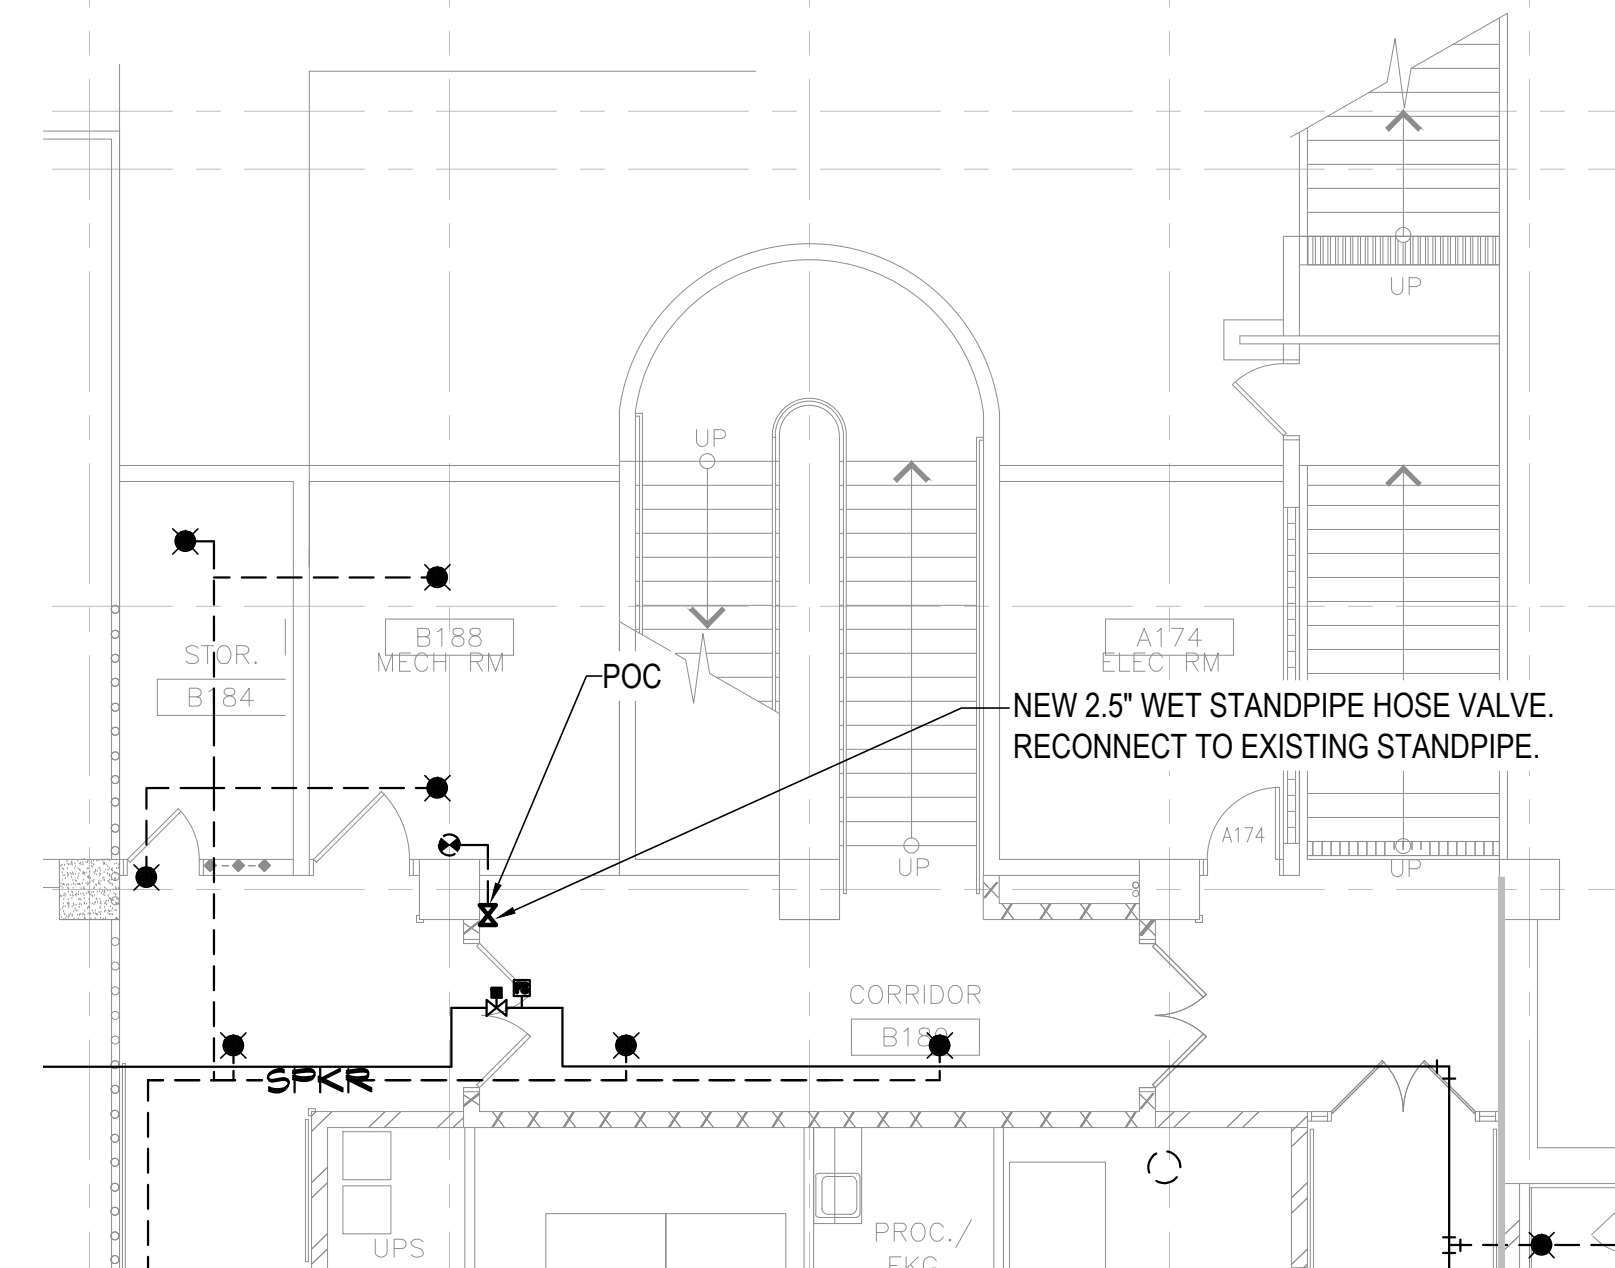


3
FP301 1/8" = 1'-0"
0" 4' 8' 16'

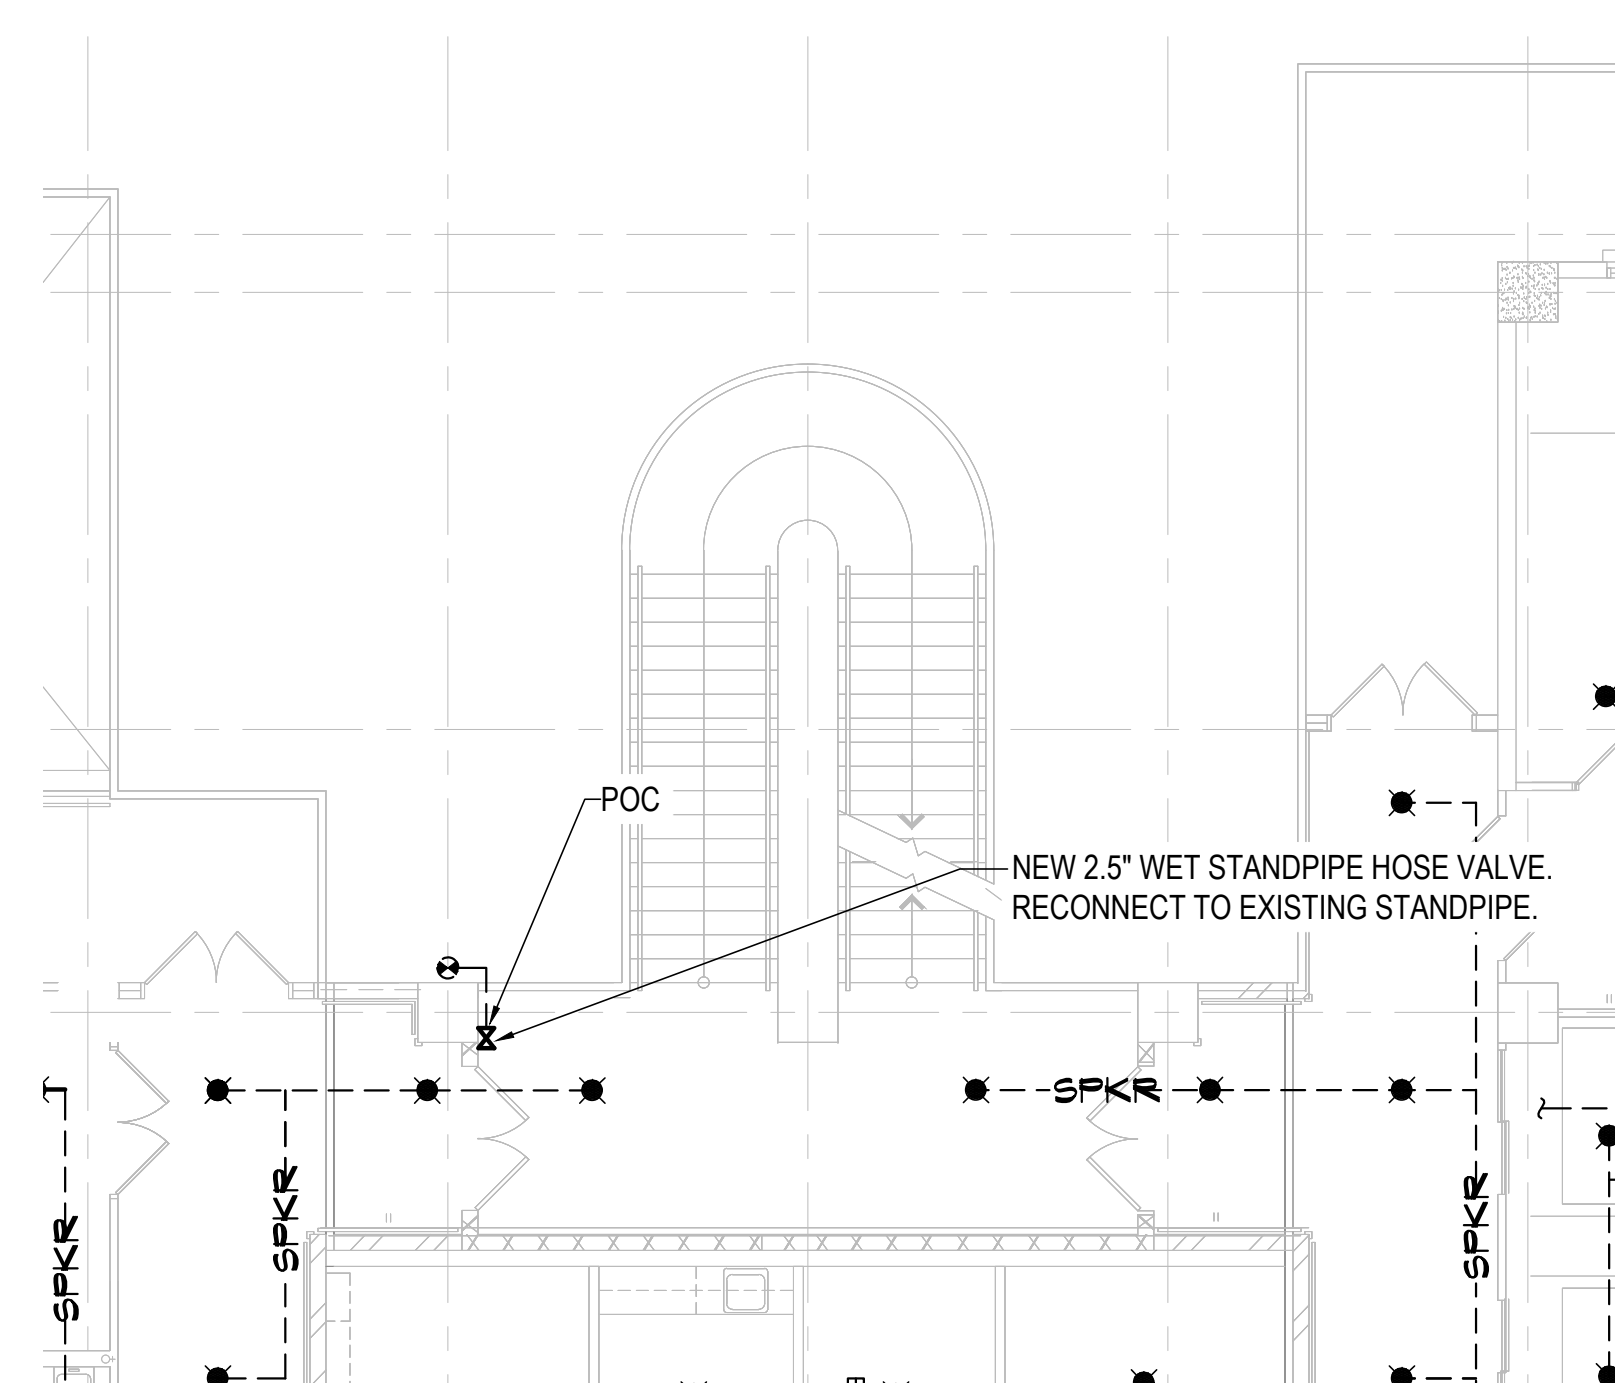

4
FP301 1/8" = 1'-0"
0" 4' 8' 16'

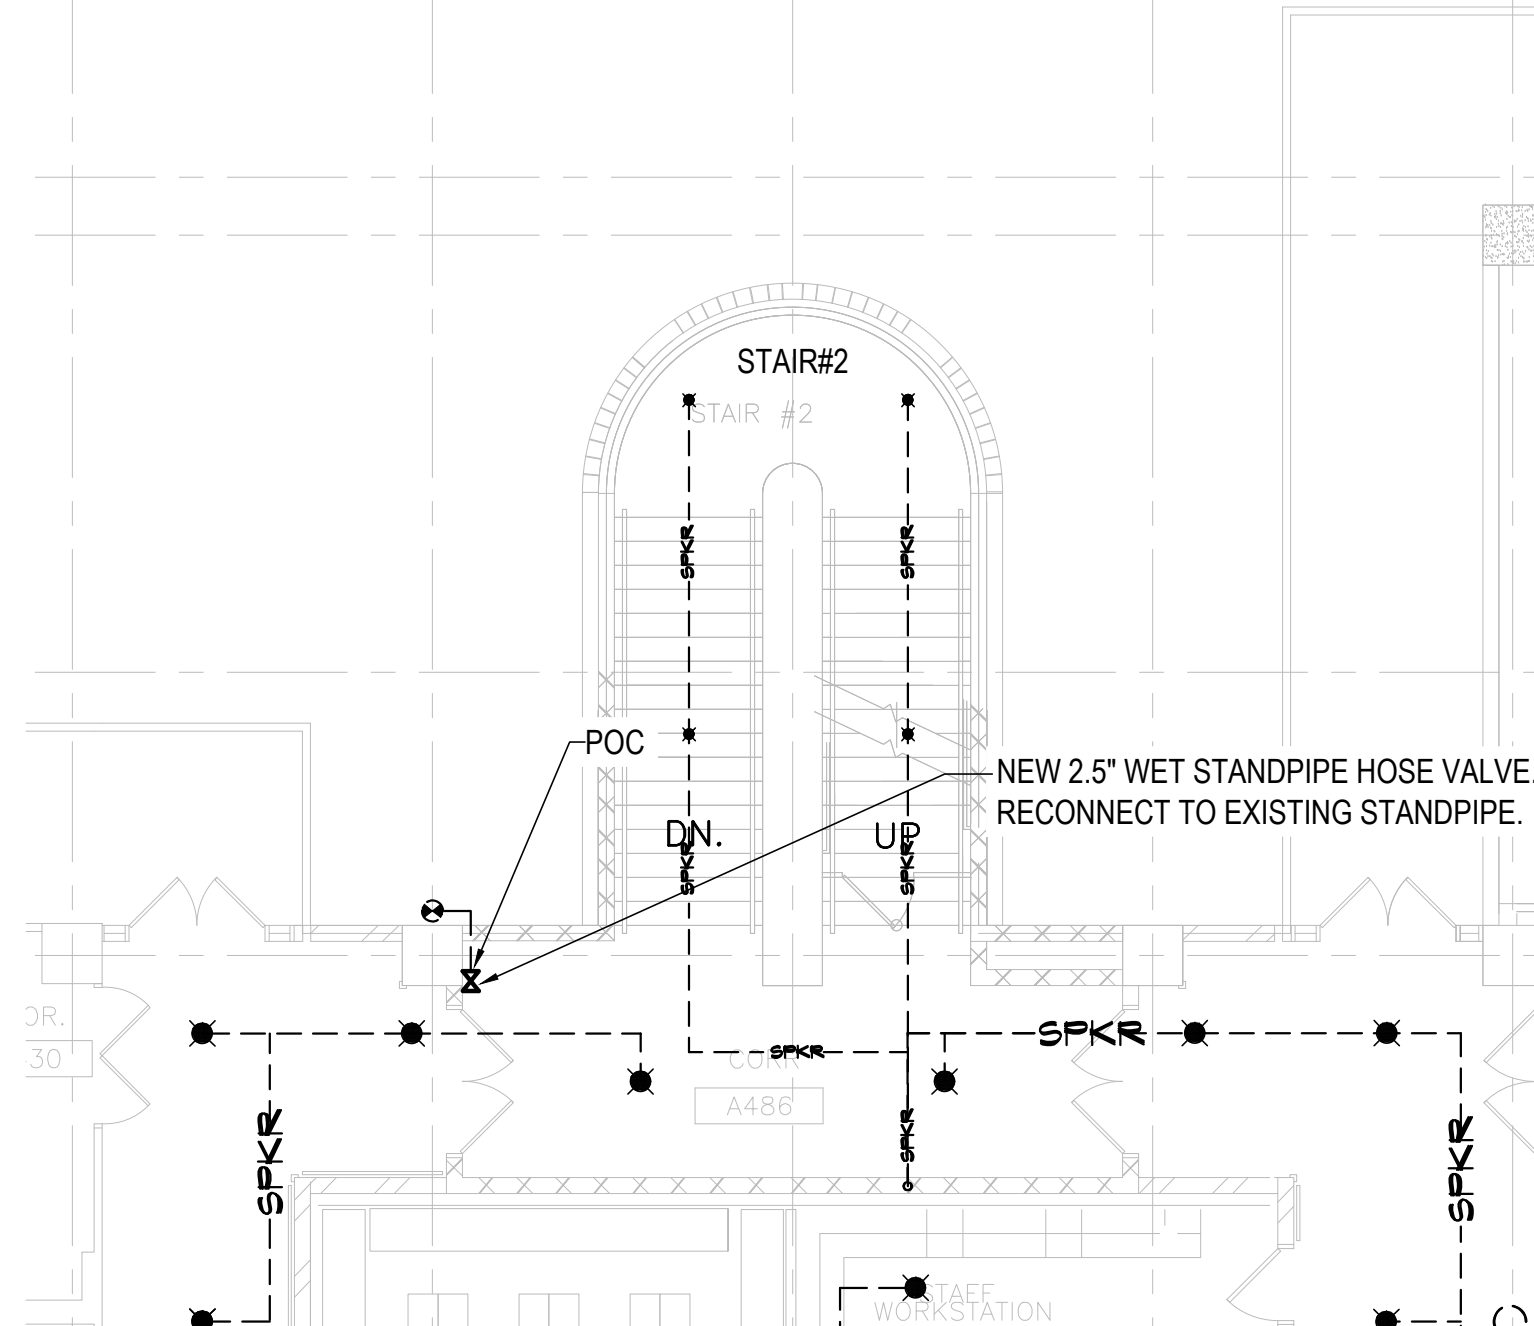


5
FP301 1/8" = 1'-0"
0" 4' 8' 16'

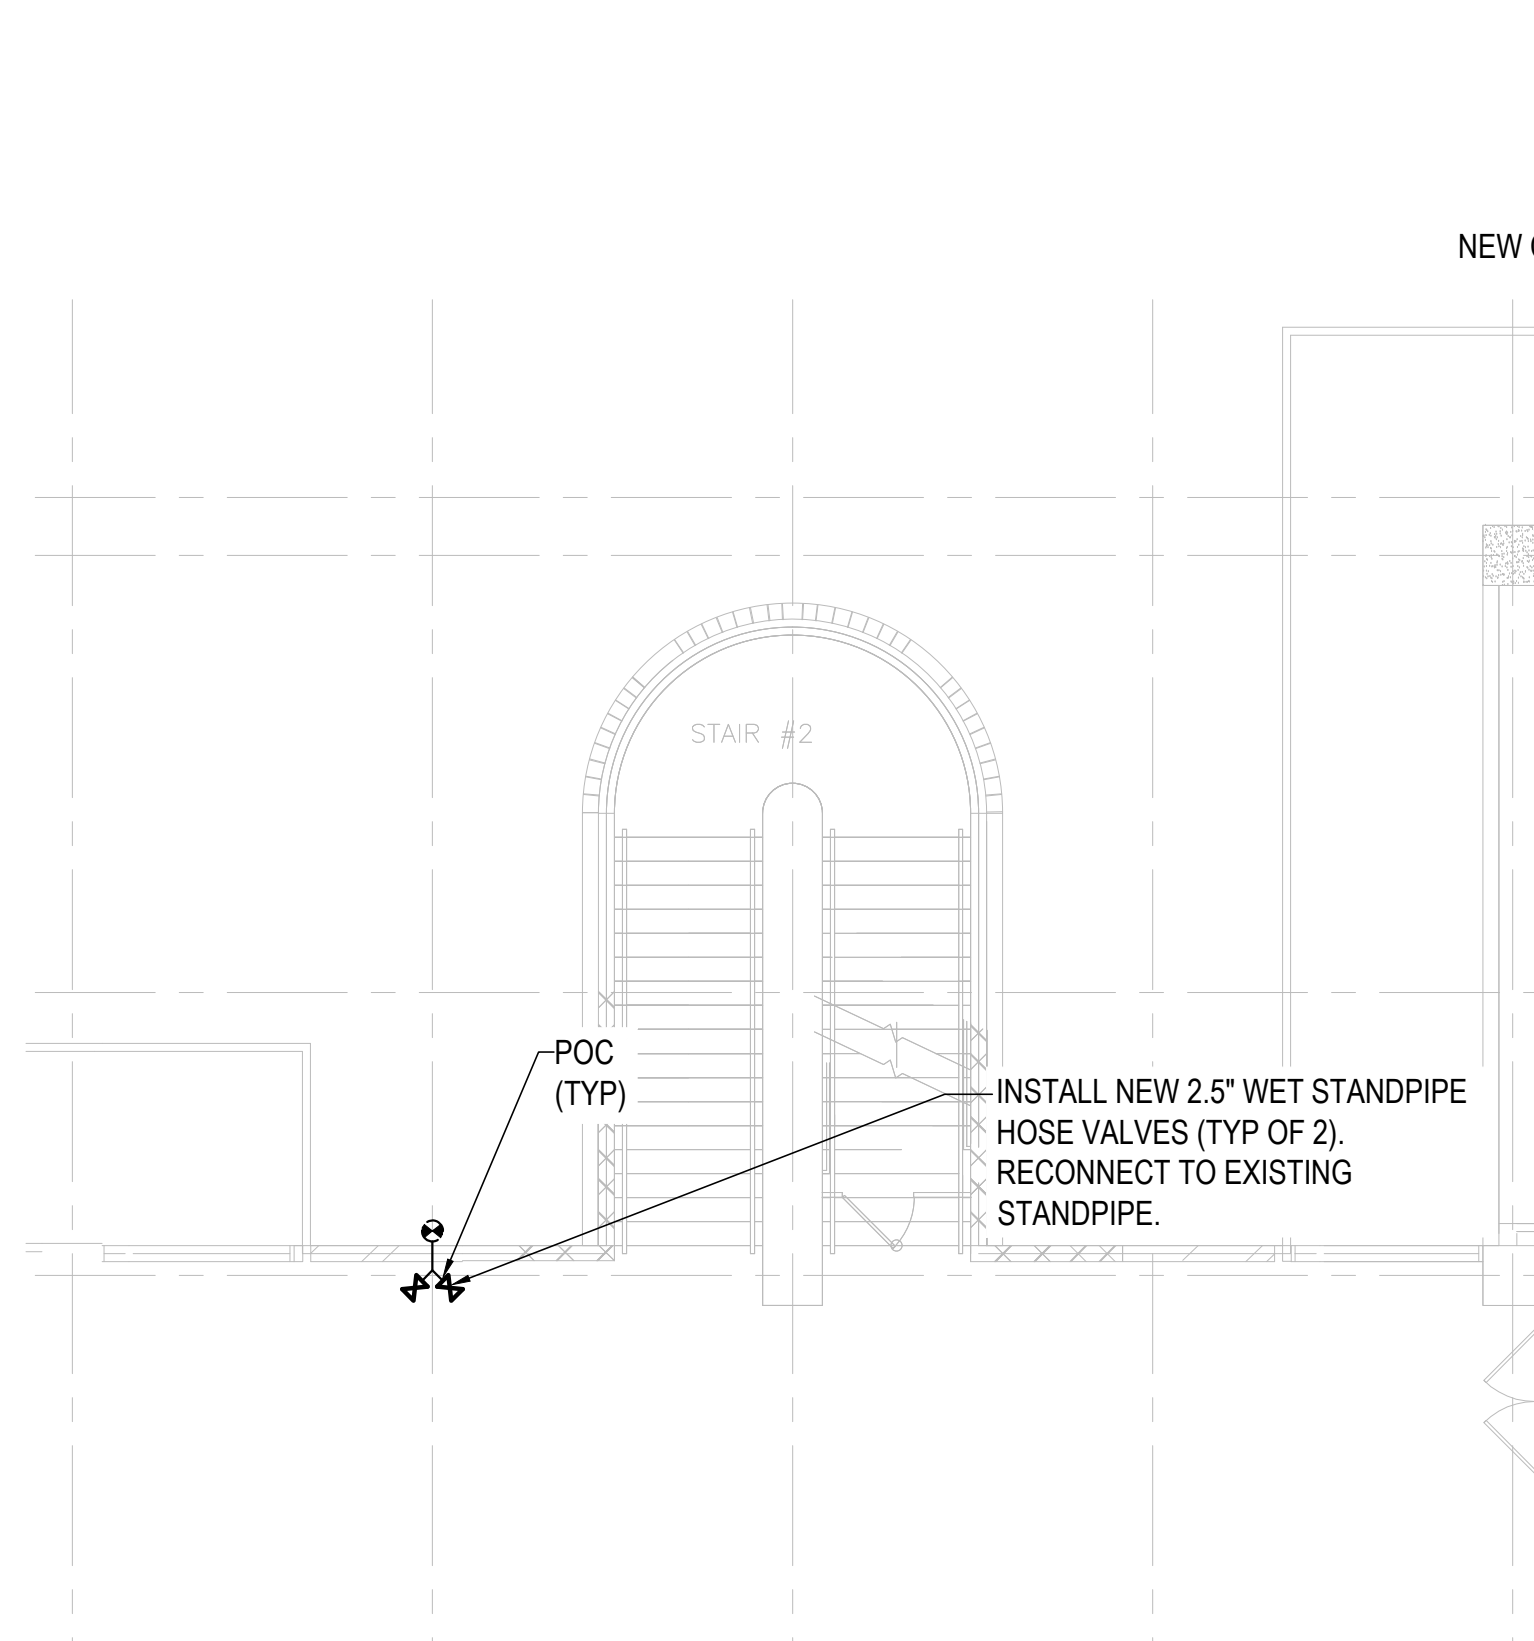


6
FP301 1/8" = 1'-0"
0" 4' 8' 16'


NOTE:
1. FIELD PAINTING - CLEAN, PRETREAT, PRIME AND PAINT PIPING. APPLY COATINGS TO CLEAN DRY SURFACES USING CLEAN BRUSHES. CLEAN THE SURFACES TO REMOVE DUST, DIRT, RUST AND LOOSE MILL SCALE. IMMEDIATELY AFTER CLEANING, PROVIDE THE METAL SURFACES WITH ONE COAT OF PRETREATMENT PRIMER APPLIED TO A MINIMUM DRY FILM THICKNESS OF 0.3 MIL AND ONE COAT OF PRIMER APPLIED TO A MINIMUM DRY FILM THICKNESS OF 1.0 MIL. PROVIDE PRIME SURFACES WITH TWO COATS OF PAINT, EXCEPT PROVIDE VALVES AND OPERATING ACCESSORIES WITH ONE COAT OF RED ALKYD GLOSS ENAMEL APPLIED TO A MINIMUM DRY FILM THICKNESS OF 1.0 MIL.

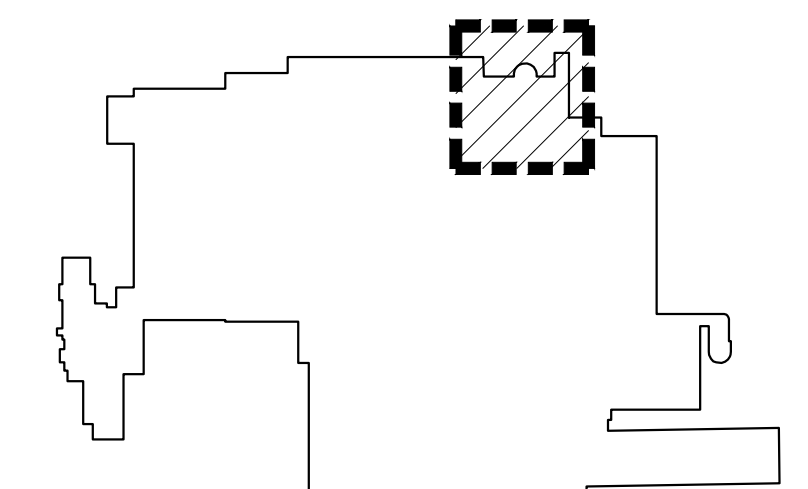

KEY PLAN - CORRIDOR BY STAIR #2 A281
NOT TO SCALE

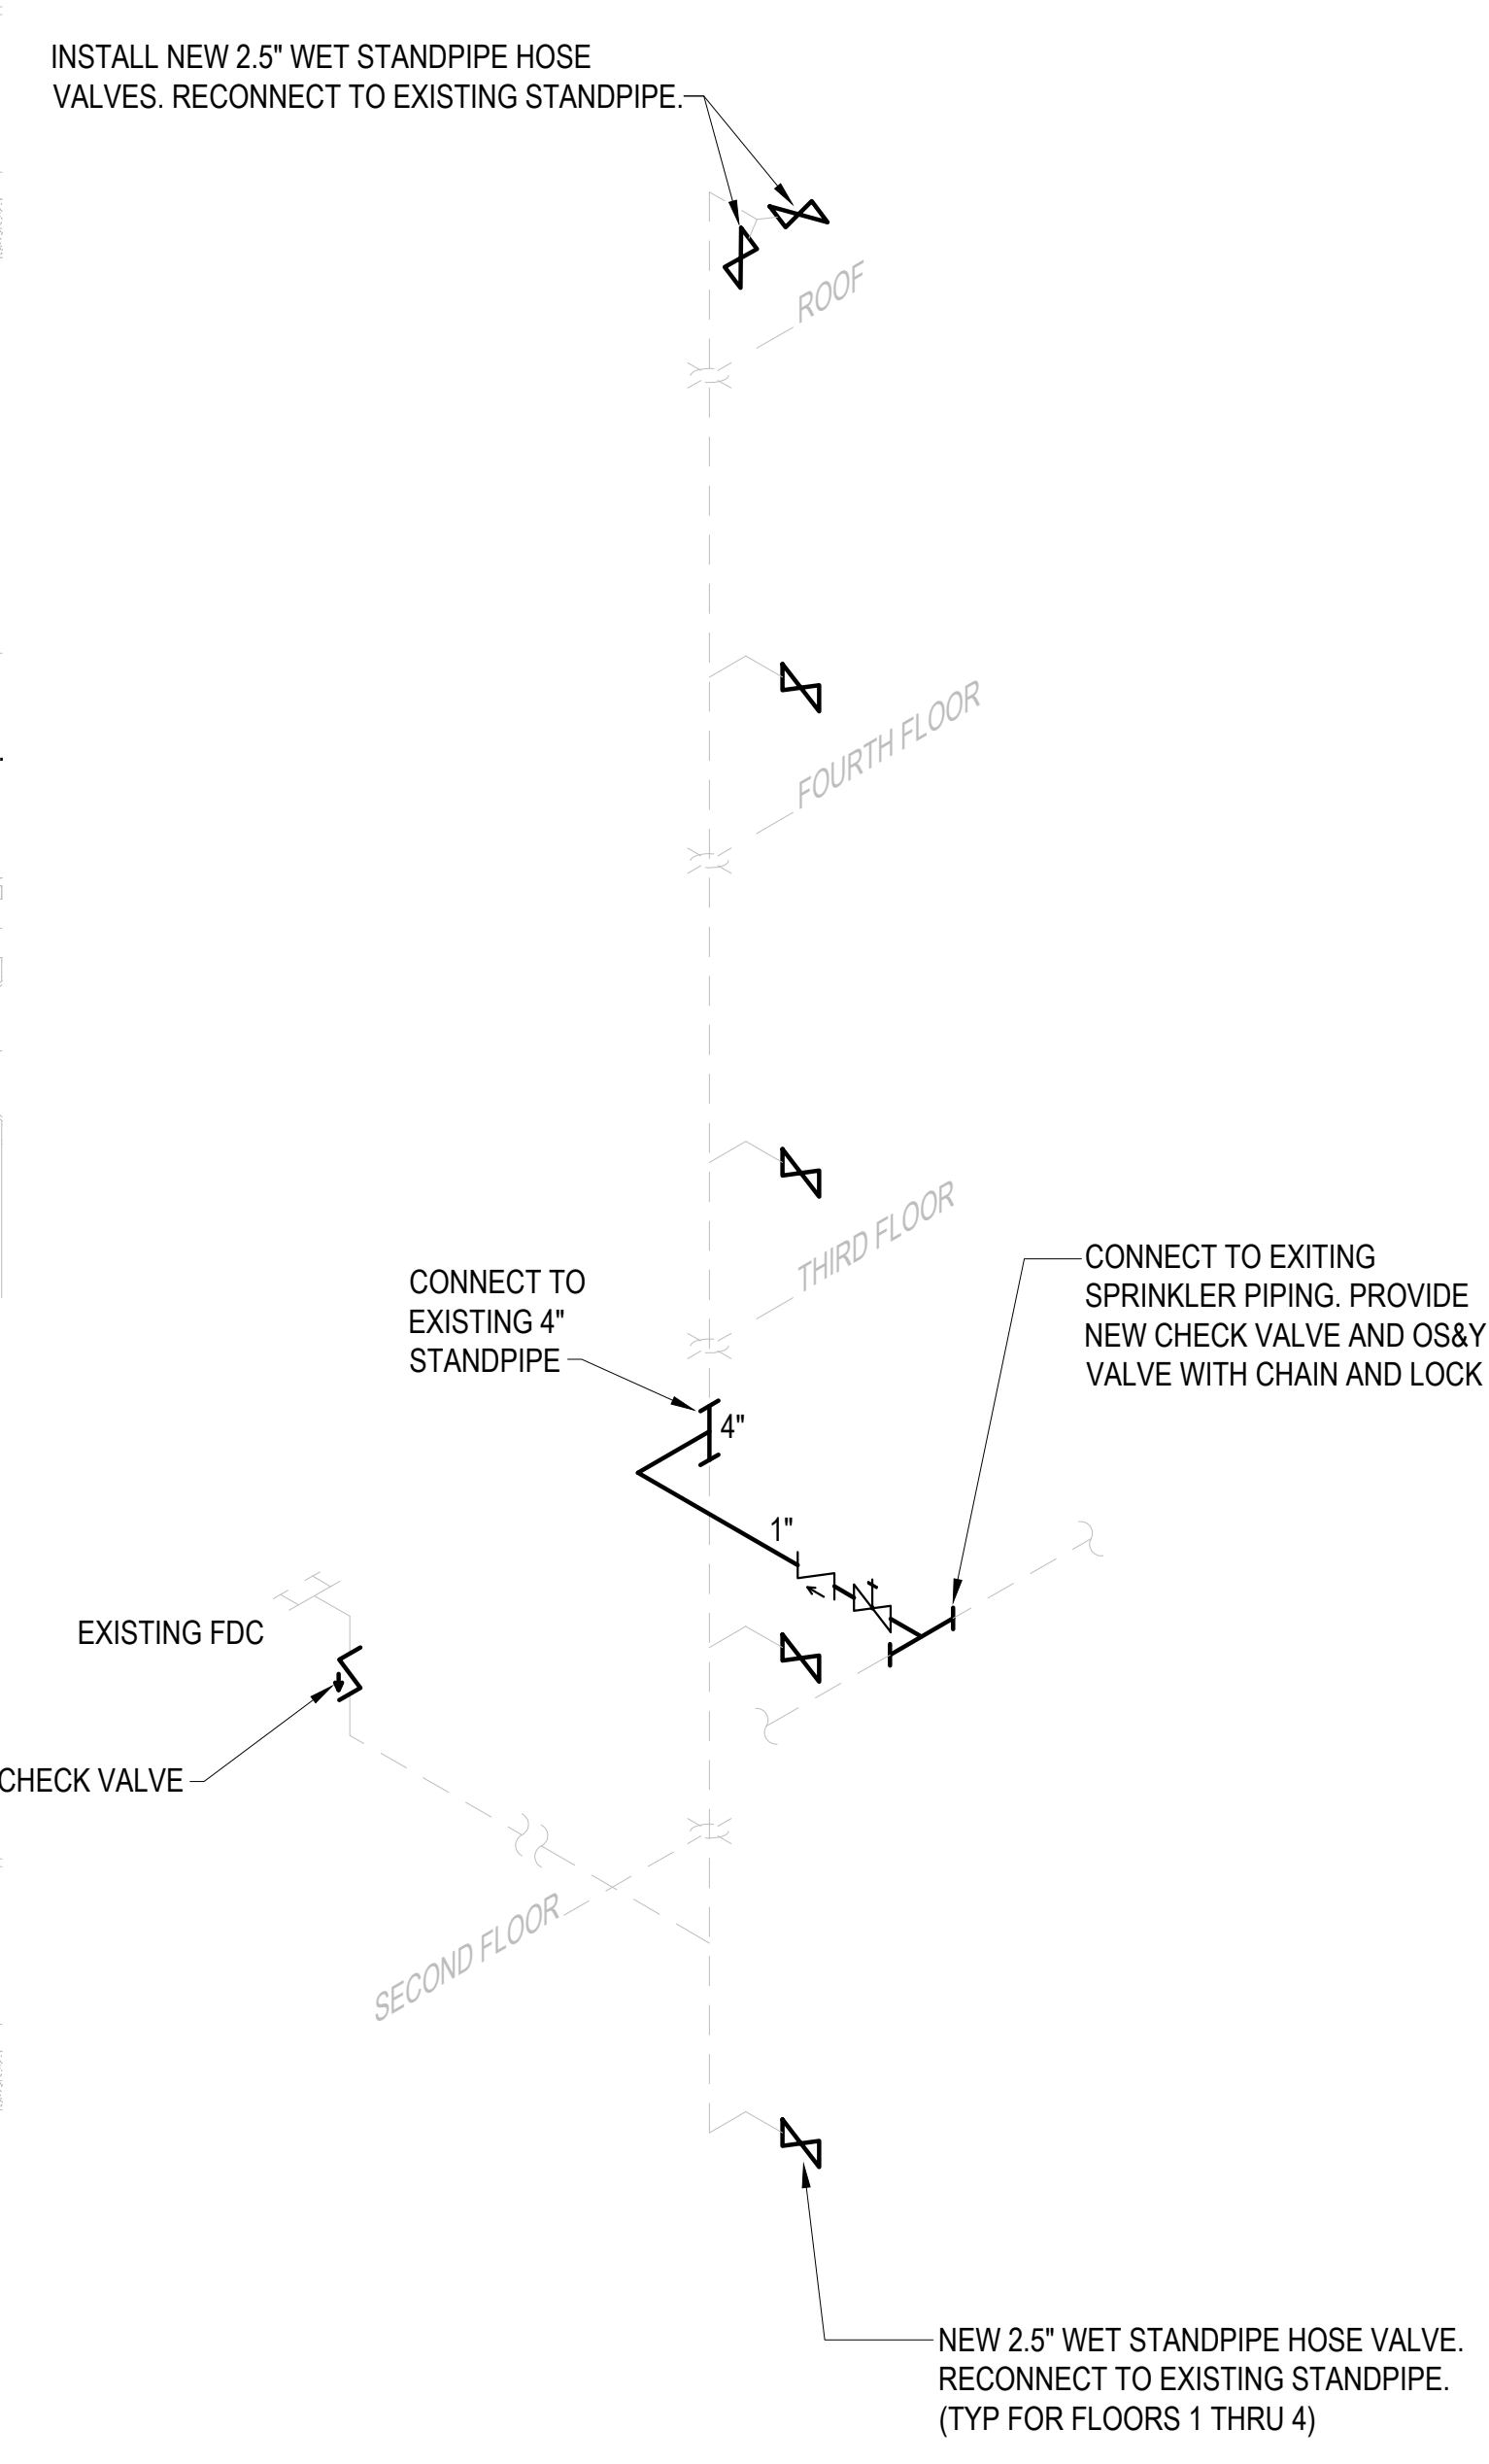

7
FP301
CORRIDOR BY STAIR #2 A281
MANUAL WET STANDPIPE RISER DIAGRAM

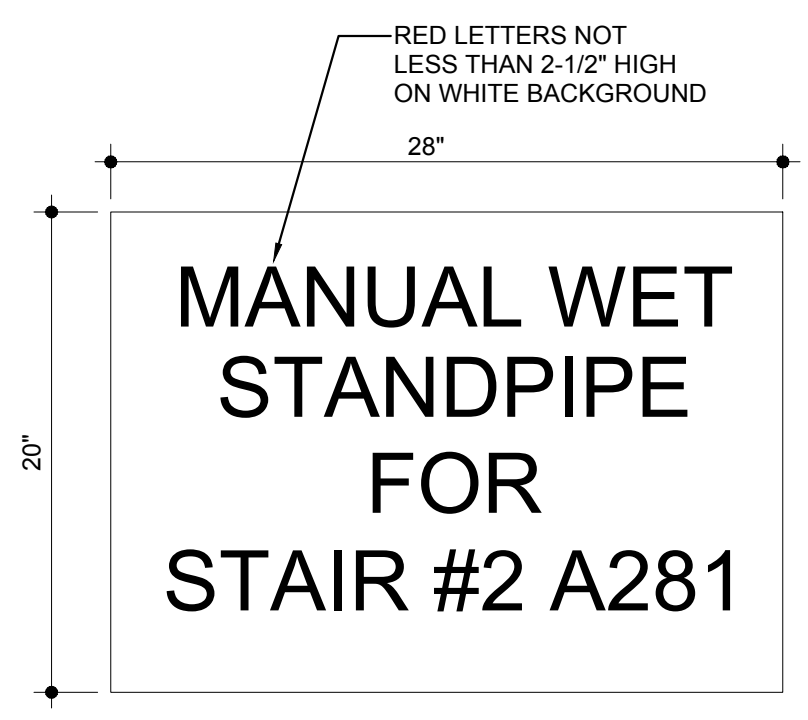

NOTE:
SIGN TO BE PERMANENTLY MARKED WEATHERPROOF METAL OR RIGID PLASTIC SIGN, SECURED WITH CORROSION-RESISTANT WIRE, CHAIN OR OTHER ACCEPTABLE MEANS.

8
FP301 1-1/2" = 1'-0"
0" 3' 6' 1' 2'

MARK	DATE	DESCRIPTION
	2024.10.25	
	144052.02	
	JBP	
	RTB	
	2024 RIM Architects	